


©2017 33 NORTH ARCHITECTS, LLC Drawings, written material, and design concepts shall not be used or reproduced in whole or part in any form or format without prior written consent of 33 North Architects. Do not scale drawings. Use given dimensions only. If not shown, verify correct dimensions with the Architect. Contractor shall check and verify

THREE NORTH

ARCHITECTS

2715 E Indian School. Road

Phoenix, AZ 85016 p. 602.707.6240

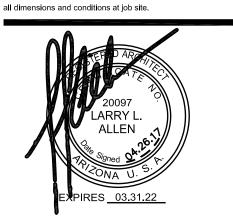


DRAWN BY: MB	CHECKED BY: LA
ISSUED:	
NO. DATE	DESCRIPTION
•	-

SITE PLAN
03.23.17

SHOP OFFICES 19' X 28' © CONF © 2' X 13 ENGINEERING PRINT/PLOT **WORK RM** 12' X 17' PHONE BALCONY OFFICE 15' X 18' BOARD ROOM 25'X 20' PROJECT STAFF BOARD ROOM 25 X 20' 6 CUBICLES @ 9' X 10'

D

2ND LEVEL PLAN A100 | SCALE: 3/32" = 1'-0"

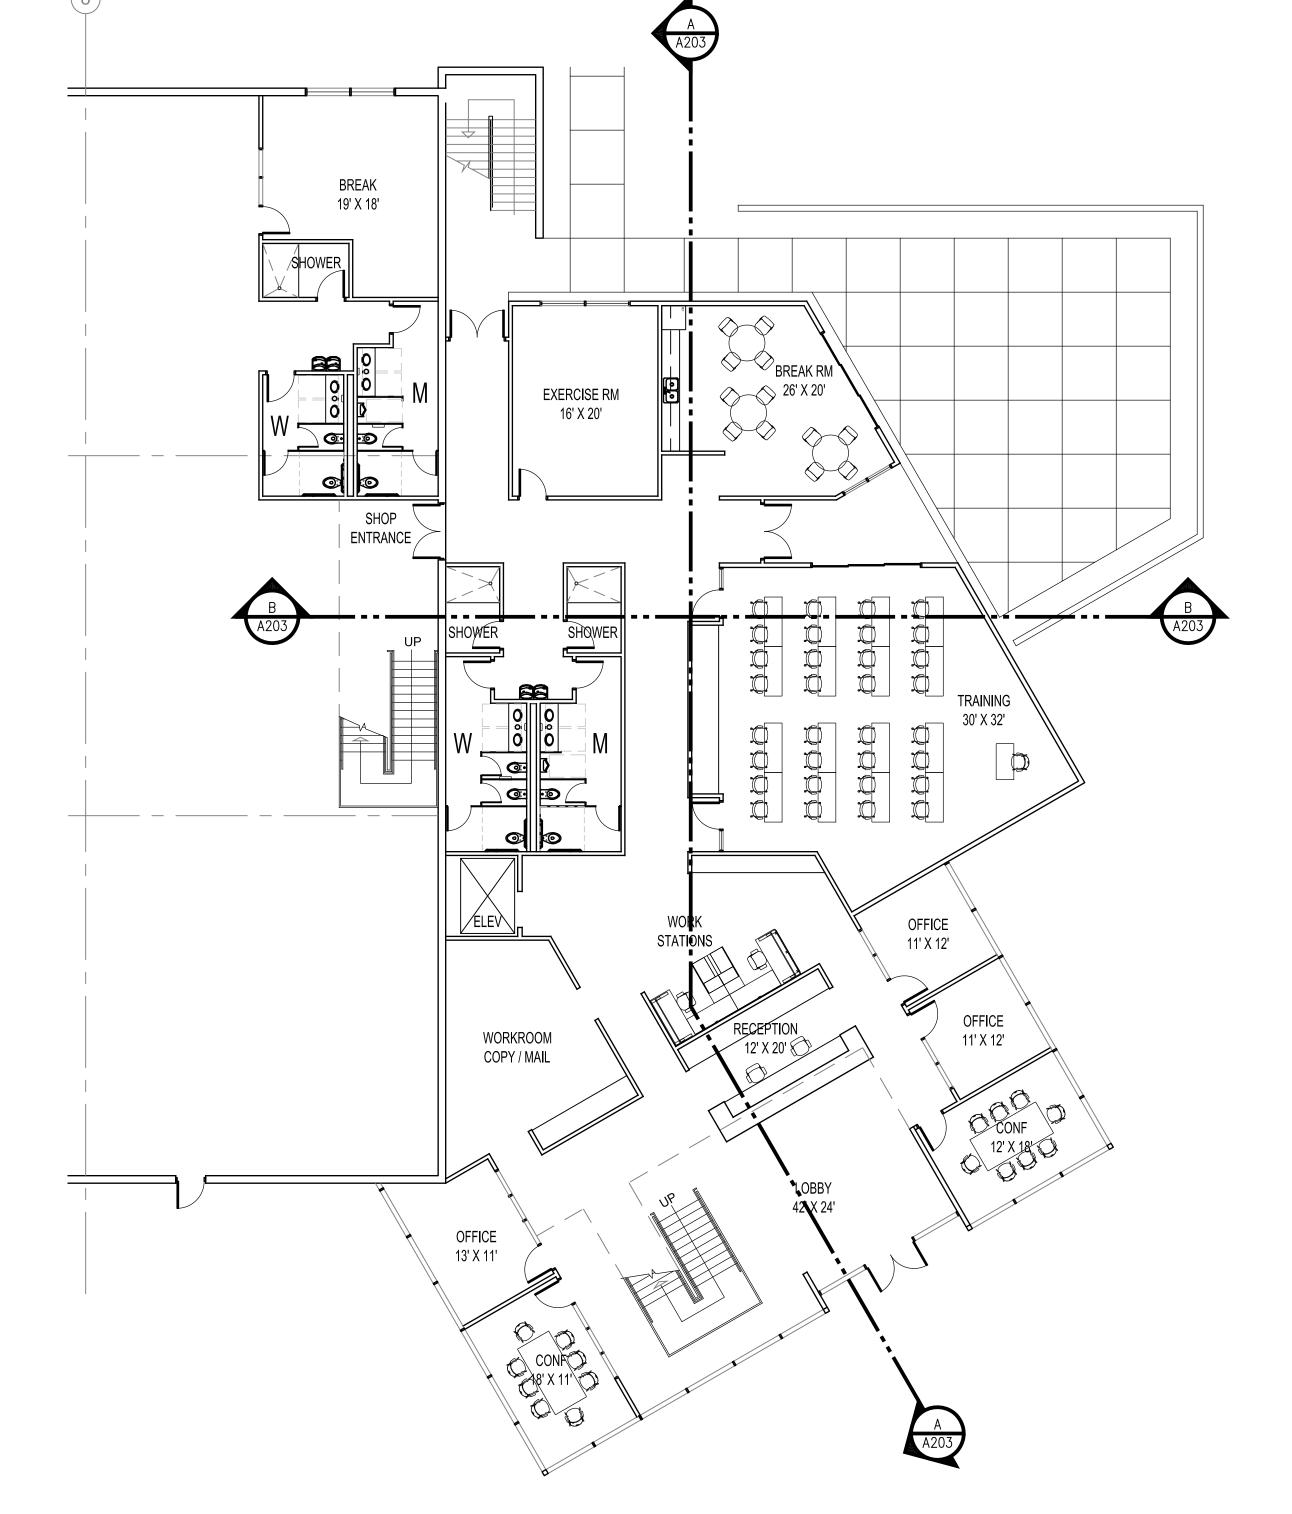


A4 MAIN LEVEL PLAN A100 | SCALE: 3/32" = 1'-0"

GENERAL NOTES:

- A. DIMENSIONS ARE TO THE FACE OF EXISTING FINISH, NEW SUBSTRATE OR GRIDLINE. "CLEAR" DIMENSIONS ARE TO FACE OF FINISH.
- B. FIELD VERIFY ALL EXISTING CONDITIONS AND THEIR COMPATIBILITY WITH NEW CONSTRUCTION PRIOR TO THE COMMENCEMENT OF WORK. COORDINATE DISCREPANCIES WITH ARCHITECT.
- C. DO NOT SCALE DRAWINGS.



©2017 33 NORTH ARCHITECTS, LLC Drawings, written material, and design concepts shall not be used or reproduced in whole or part in any form or format without prior written consent of 33 North Architects. Do not scale drawings. Use given dimensions only. If not shown, verify correct dimensions with the Architect. Contractor shall check and verify all dimensions and conditions at job site.

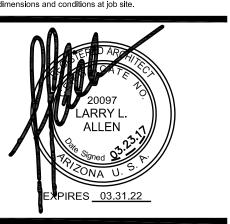

PROJECT NO. 16007				
DRAWN BY: MB	CHECKED BY: LA			
ISSUED:				
NO. DATE	DESCRIPTION			
SHEET NAME				

FLOOR PLANS
03.23.17

- A. DIMENSIONS ARE TO THE FACE OF EXISTING FINISH, NEW SUBSTRATE OR GRIDLINE. "CLEAR" DIMENSIONS ARE TO FACE OF FINISH.
- B. FIELD VERIFY ALL EXISTING CONDITIONS AND THEIR COMPATIBILITY WITH NEW CONSTRUCTION PRIOR TO THE COMMENCEMENT OF WORK. COORDINATE DISCREPANCIES WITH ARCHITECT.
- C. DO NOT SCALE DRAWINGS.

D

NORTH
A3 MAIN LEVEL PLAN - WAREHOUSE

SCALE: 1/16" = 1'-0"


THIRTY
THREE
NORTH

ARCHITECTS

2715 E Indian School. Road
Phoenix, AZ 85016
p: 602.707.6240

BUILDING CONCEPAND INDUSTRIAL PARK

©2017 33 NORTH ARCHITECTS, LLC
Drawings, written material, and design concepts shall not be used or reproduced in whole or part in any form or format without prior written consent of 33 North Architects. Do not scale drawings. Use given dimensions only. If not shown, verify correct dimensions with the Architect. Contractor shall check and verify all dimensions and conditions at job site.

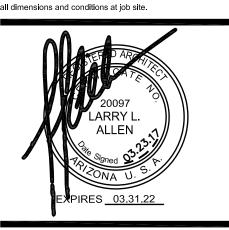

PROJECT NO. 16007

DRAWN BY: MB CHECKED BY: LA

ISSUED:


NO. DATE DESCRIPTION

SHEET NAME

WAREHOUSE WAREHOUSE

03.23.17 V

A101

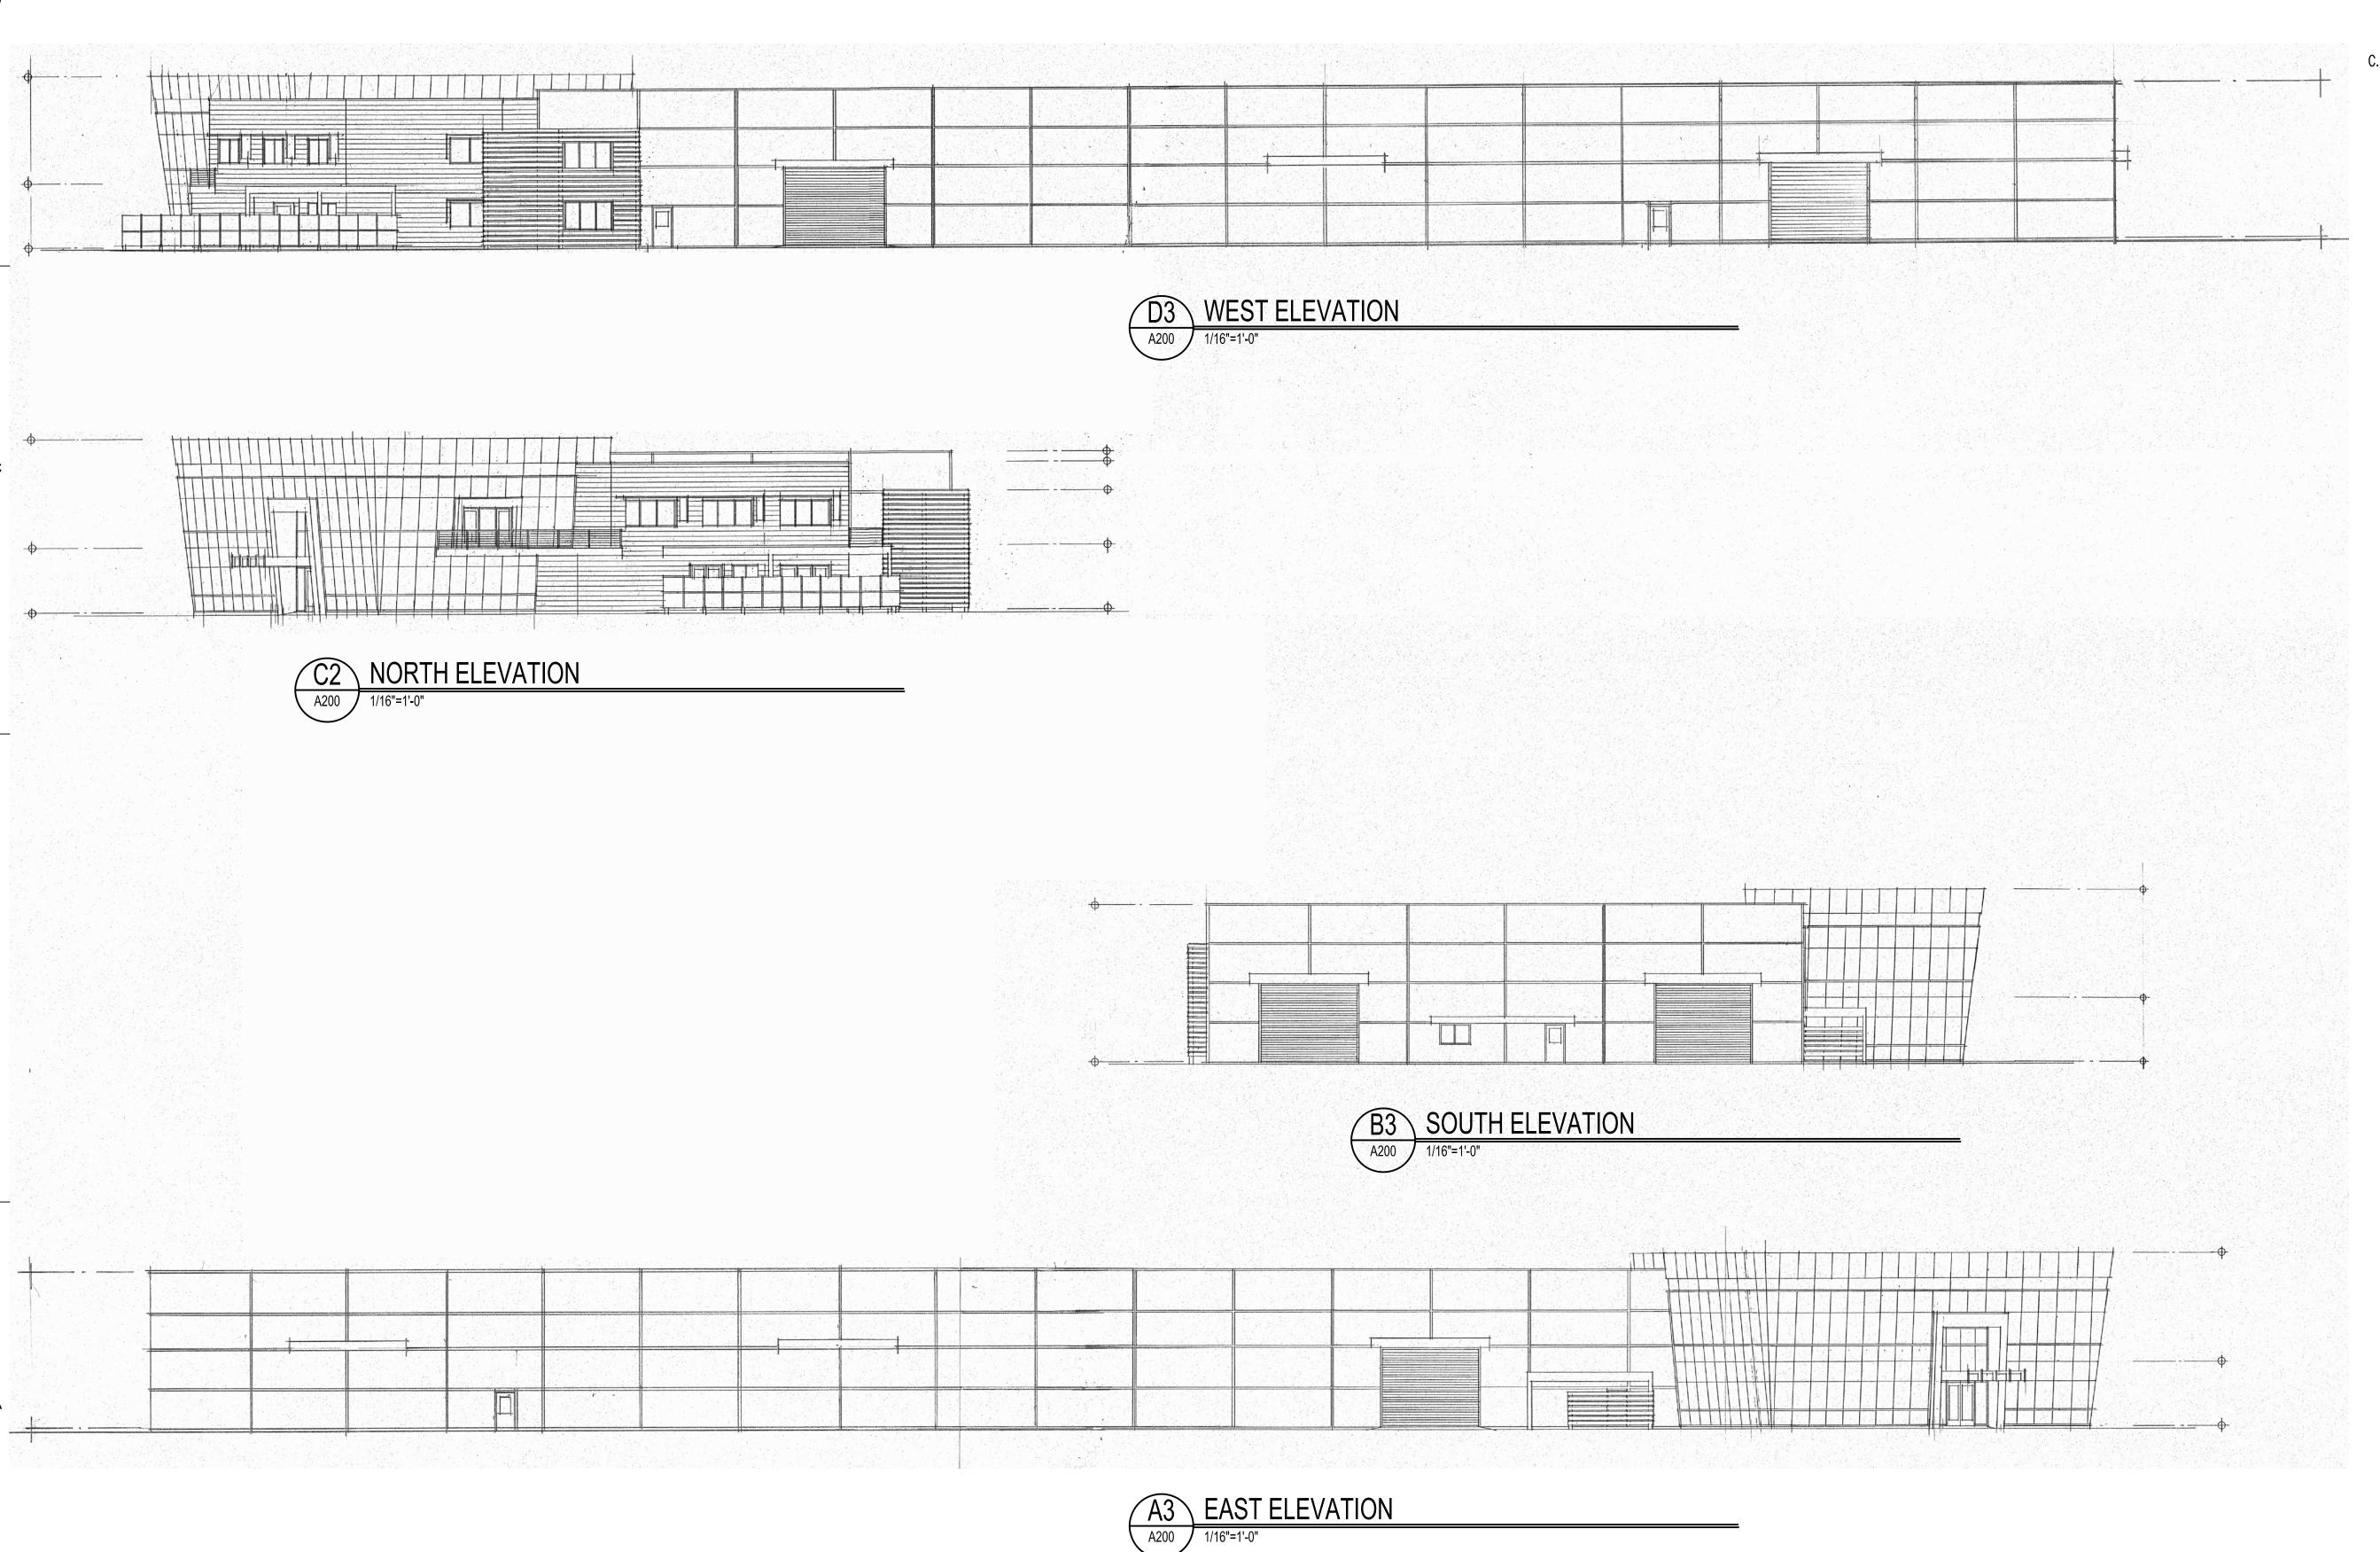


- A. DIMENSIONS ARE TO THE FACE OF EXISTING FINISH, NEW SUBSTRATE OR GRIDLINE. "CLEAR" DIMENSIONS ARE TO FACE OF FINISH.
- B. FIELD VERIFY ALL EXISTING CONDITIONS AND THEIR COMPATIBILITY WITH NEW CONSTRUCTION PRIOR TO THE COMMENCEMENT OF WORK. COORDINATE DISCREPANCIES WITH ARCHITECT.
- C. DO NOT SCALE DRAWINGS.



STHARCHITECTS, LLC then material, and design concepts so the of 33 North Architects Do not of 33

©2017 33 NORTH ARCHITECTS, LLC
Drawings, written material, and design concepts shall not be used or reproduced in whole or part in any form or format without prior written consent of 33 North Architects. Do not scale drawings.
Use given dimensions only. If not shown, verify correct dimensions with the Architect. Contractor shall check and verify all dimensions and conditions at job site.

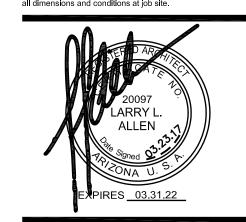

SSUED:		
NO.	DATE	DESCRIPTION

OVERALL

BUILDING

FI EVATION

ELEVATIONS

03.23.17

¯ ≝**A20**0

 6" WIDE CONCRETE TILT WALL REVEALS, TYP. CONCRETE TILT WALL _ STEEL FACED LED LIGHT FIXTURE +35'-0" — OVERHEAD ROLL-UP DOOR 20'W X 16'H B3 WEST ELEVATION A201 1/8"=1'-0" — ACM PANELS - HORIZONTAL METAL SLAT - HORIZONTAL METAL BUILDING SKIN SCREEN WALL +35'-0" T.O. PARAPET +35'-0" T.O. PARAPET +30'-0" T.O. SCREEN +30'-0" SECOND LEVEL +13'-0" SECOND LEVEL +13'-0" HO'-O" MAIN LEVEL — GLASS CURTAIN WALL PERFORATED STEEL - PATIO SHADE STRUCTURE SCREEN WALL NORTH ELEVATION

GENERAL NOTES:

- A. DIMENSIONS ARE TO THE FACE OF EXISTING FINISH, NEW SUBSTRATE OR GRIDLINE. "CLEAR" DIMENSIONS ARE TO FACE OF FINISH.
- B. FIELD VERIFY ALL EXISTING CONDITIONS AND THEIR COMPATIBILITY WITH NEW CONSTRUCTION PRIOR TO THE COMMENCEMENT OF WORK. COORDINATE DISCREPANCIES WITH ARCHITECT.
- C. DO NOT SCALE DRAWINGS.




p: 602.707.6240

NEW BUILDING CONCEPT OFFICE AND INDUSTRIAL PARK

©2017 33 NORTH ARCHITECTS, LLC

Drawings, written material, and design concepts shall not be used or reproduced in whole or part in any form or format without prior written consent of 33 North Architects. Do not scale drawings. Use given dimensions only. If not shown, verify correct dimensions with the Architect. Contractor shall check and verify

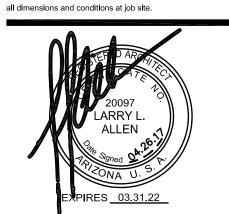

	1			
PROJECT NO. 16007				
DRAWN BY: MB CHECKED BY: LA				
ISSUED:				
NO.	DATE	DESCRIPTION		
CHEET	IANAE			

ENLARGED
BUILDING
ELEVATIONS

03.23.17

A201

6" WIDE CONCRETE TILT WALL REVEALS, TYP. CONCRETE TILT WALL T.O. PARAPET +35'-0" T.O. PARAPET -SECOND LEVEL +13'-0" → MAIN LEVEL +0'-0" B3 SOUTH ELEVATION A202 1/8"=1'-0" - STEEL FACED LED LIGHT FIXTURE - T.O. PARAPET +35'-0" SIGNAGE ___ SECOND LEVEL +13'-0" 11 ----MAIN LEVEL +0'-0" — HORIZONTAL METAL SLAT SCREEN WALL — PATIO SHADE - OVERHEAD ROLL-UP DOOR 20'W X 16'H STRUCTURE EAST ELEVATION

GENERAL NOTES:


- A. DIMENSIONS ARE TO THE FACE OF EXISTING FINISH, NEW SUBSTRATE OR GRIDLINE. "CLEAR" DIMENSIONS ARE TO FACE OF FINISH.
- B. FIELD VERIFY ALL EXISTING CONDITIONS AND THEIR COMPATIBILITY WITH NEW CONSTRUCTION PRIOR TO THE COMMENCEMENT OF WORK. COORDINATE DISCREPANCIES WITH ARCHITECT.
- C. DO NOT SCALE DRAWINGS.



Phoenix, AZ 85016

p: 602.707.6240

©2017 33 NORTH ARCHITECTS, LLC Drawings, written material, and design concepts shall not be used or reproduced in whole or part in any form or format without prior written consent of 33 North Architects. Do not scale drawings. Use given dimensions only. If not shown, verify correct dimensions with the Architect. Contractor shall check and verify

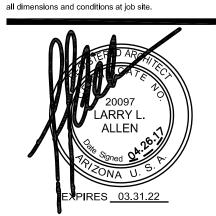

	1				
PROJEC [*]	PROJECT NO. 16007				
DRAWN I	BY: MB	CHECKED BY:	LA		
ISSUED:					
NO.	DATE	DESCRIPTION			
SHEET N	IAME	·			


ENLARGED ≥ BUILDING

ELEVATIONS

O3.23.17


A 202

- A. DIMENSIONS ARE TO THE FACE OF EXISTING FINISH, NEW SUBSTRATE OR GRIDLINE. "CLEAR" DIMENSIONS ARE TO FACE OF FINISH.
- B. FIELD VERIFY ALL EXISTING CONDITIONS AND THEIR COMPATIBILITY WITH NEW CONSTRUCTION PRIOR TO THE COMMENCEMENT OF WORK. COORDINATE DISCREPANCIES WITH ARCHITECT.
- C. DO NOT SCALE DRAWINGS.

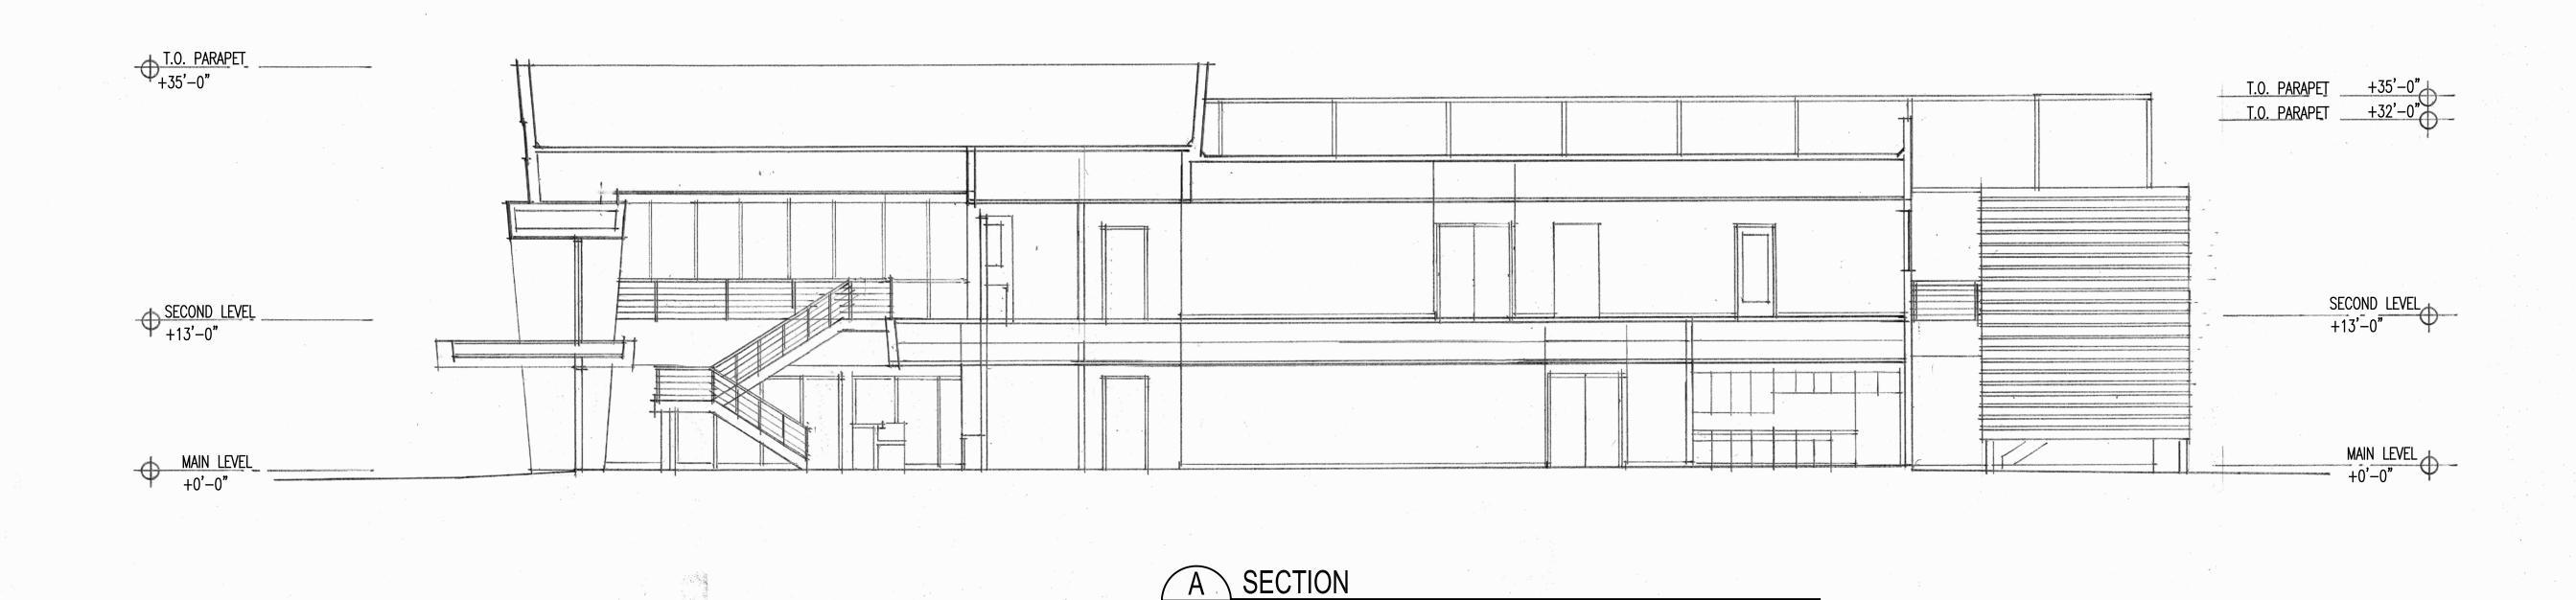

A203 1/8"=1'-0"

D

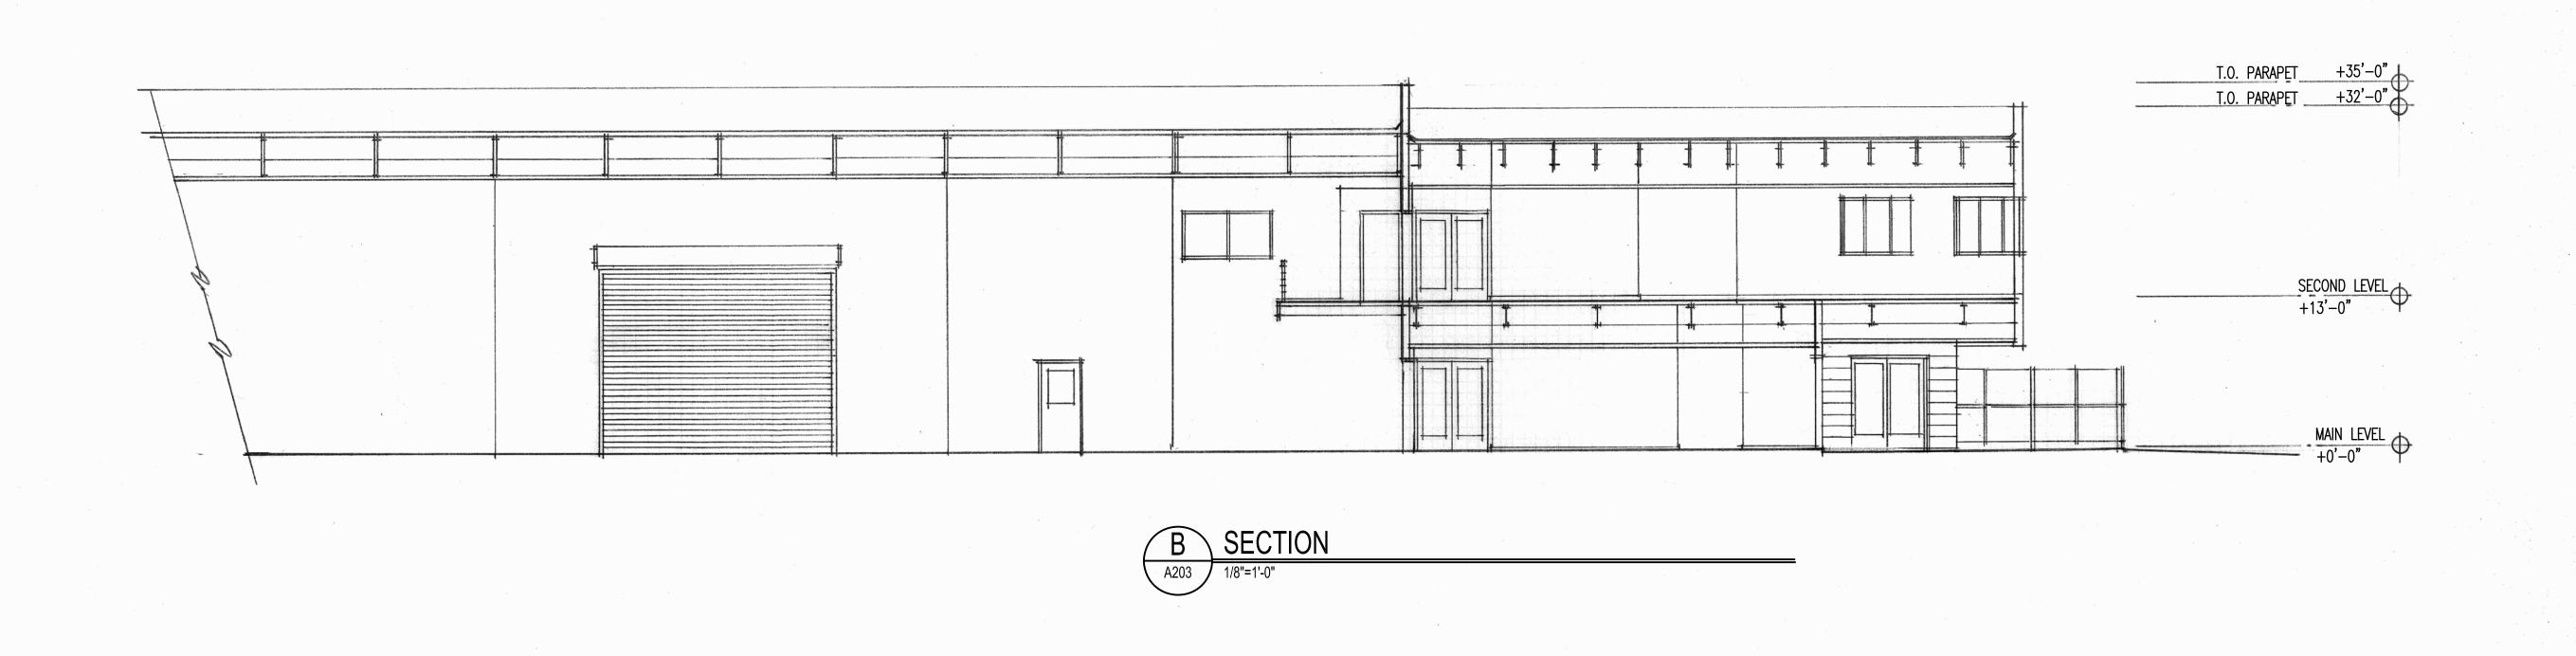

EW BUILDING CONCEPT FICE AND INDUSTRIAL PARK

THIRTY THREE NORTH

ARCHITECTS

2715 E Indian School. Road Phoenix, AZ 85016 p: 602.707.6240

©2017 33 NORTH ARCHITECTS, LLC
Drawings, written material, and design concepts shall not be used or reproduced in whole or part in any form or format without prior written consent of 33 North Architects. Do not scale drawings.
Use given dimensions only. If not shown, verify correct




DRAWN BY: MB	CHECKED BY: LA
SSUED:	
NO. DATE	DESCRIPTION

ENLARGED
BUILDING
ELEVATIONS

03.23.17 03.23.17


A202

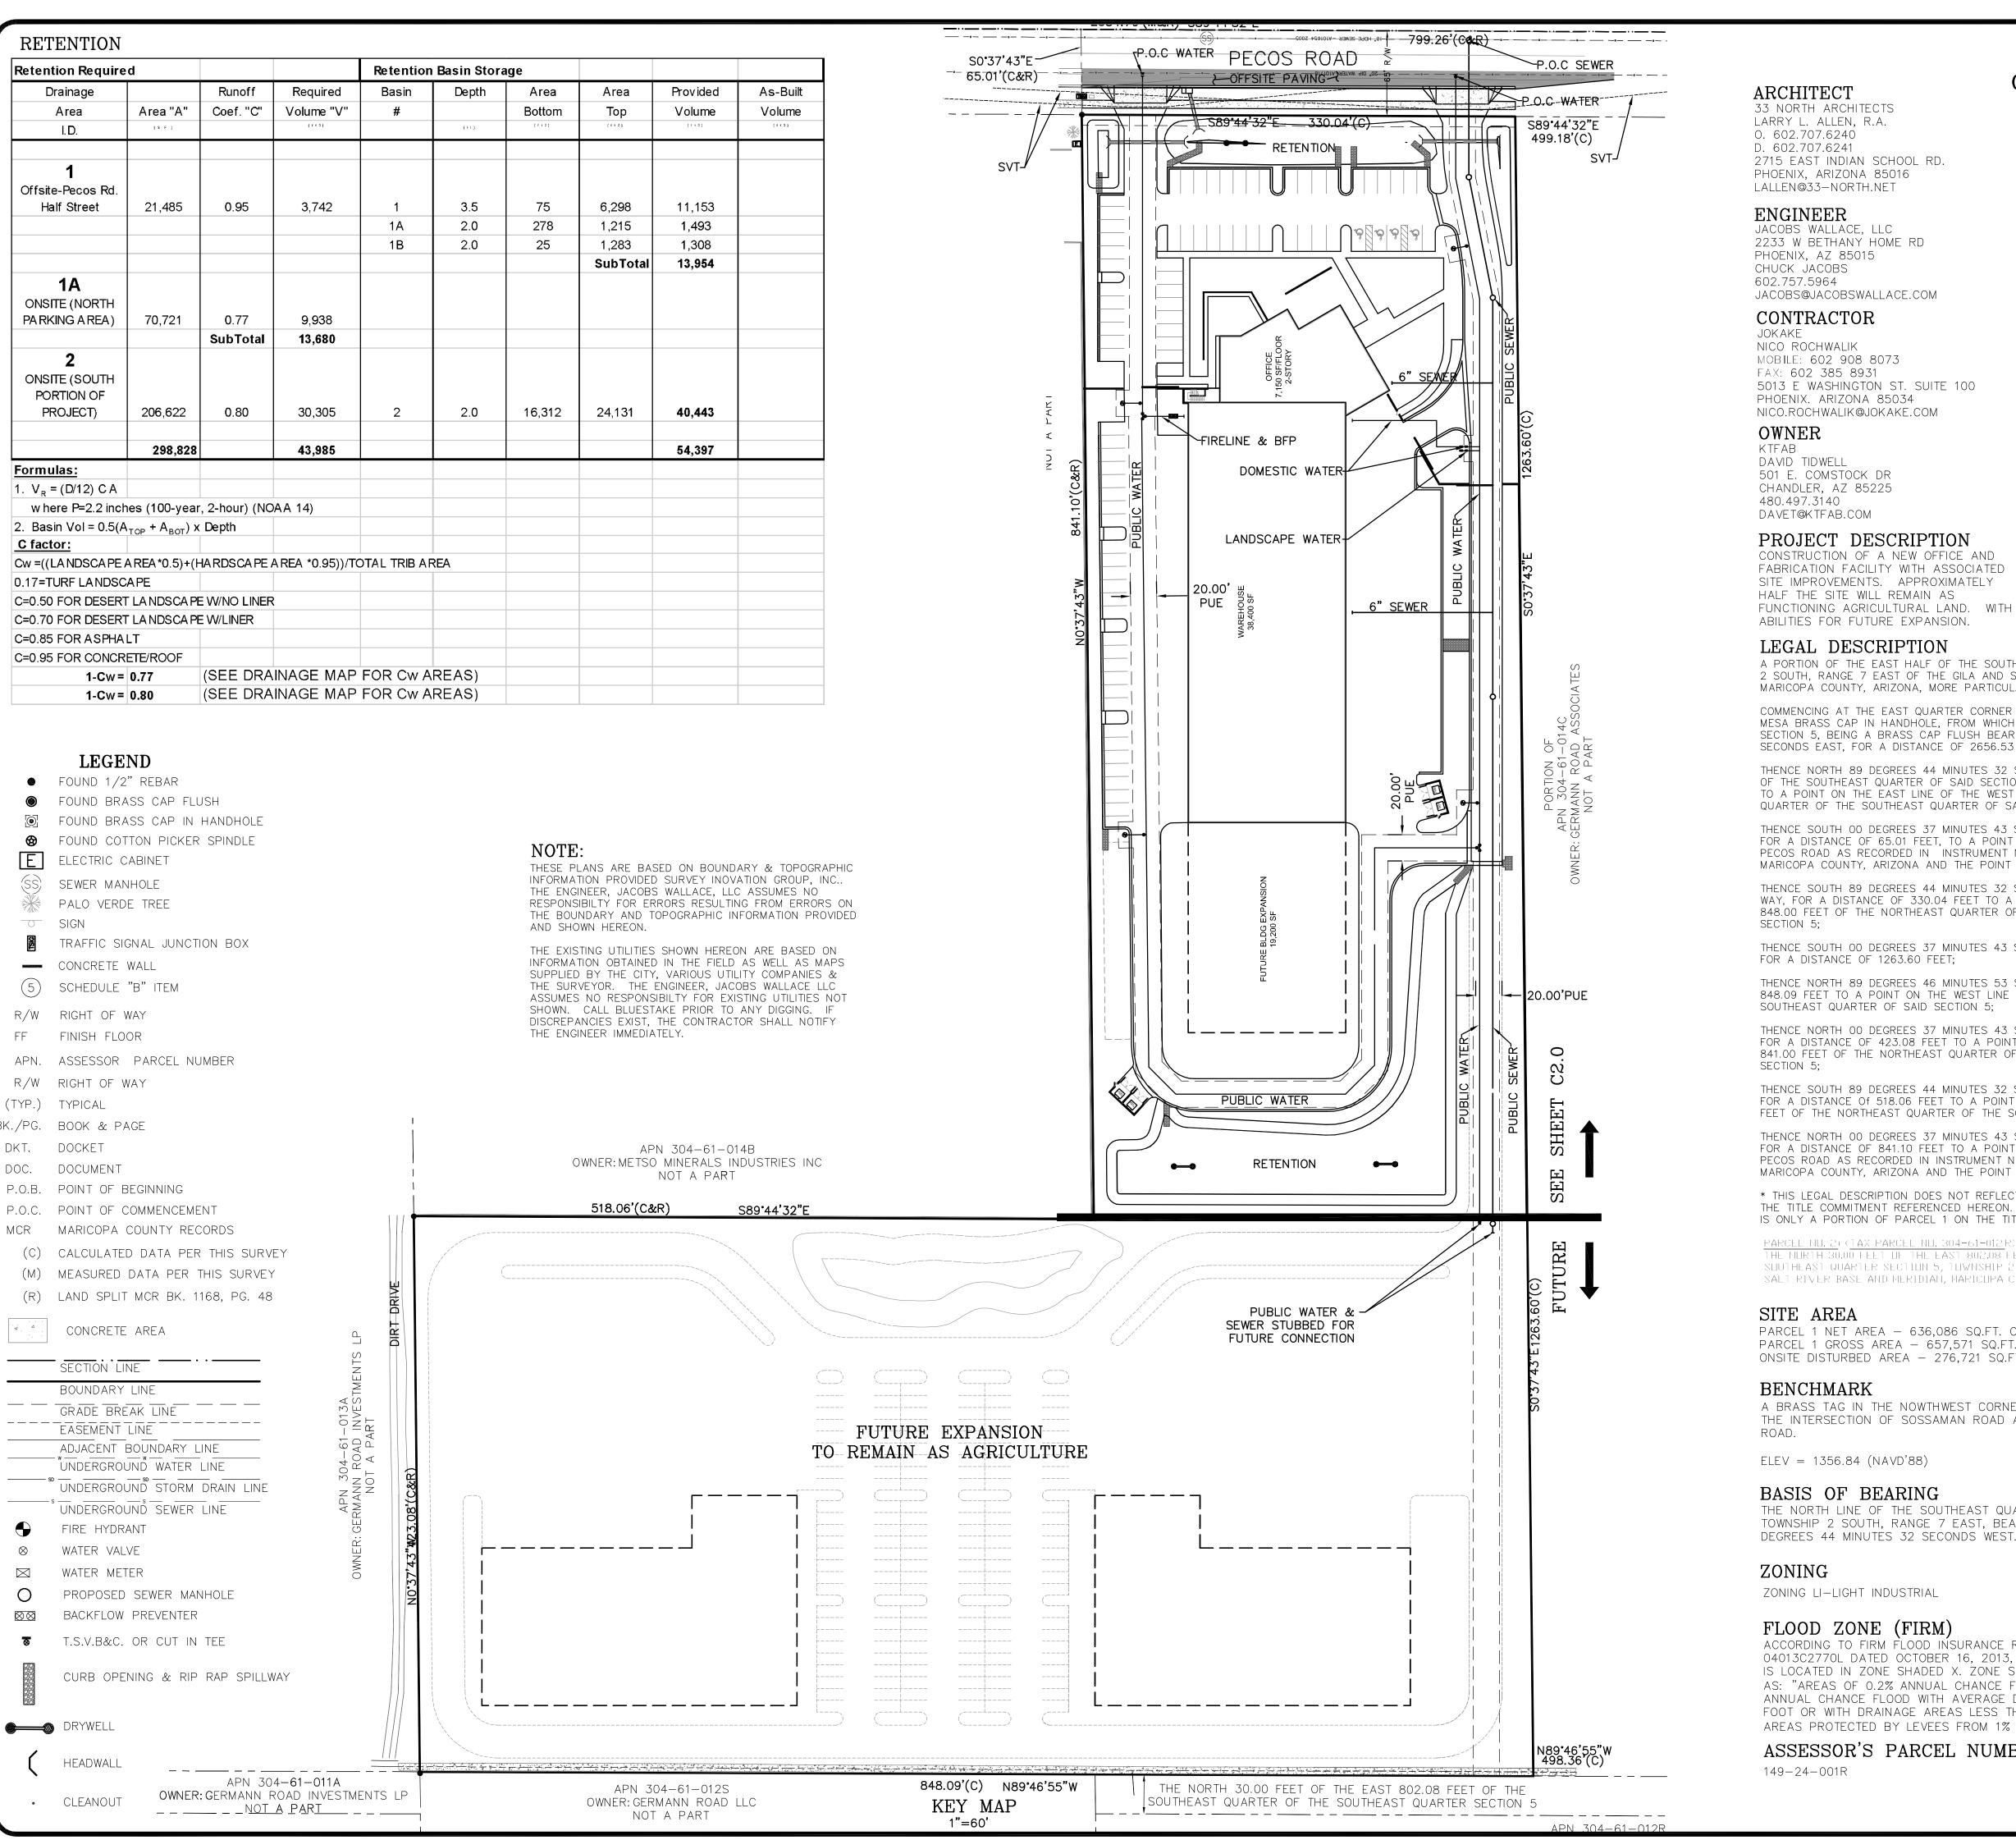

NEW BUILDING CONCEPT OFFICE AND INDUSTRIAL PARK CONCEPTUAL

GRADING & DRAINAGE PLAN AND UTILITY PLAN 8300 E. PECOS ROAD

A PORTION OF THE SOUTHEAST QUARTER OF SECTION 05, TOWNSHIP 2 SOUTH, RANGE 7 EAST OF THE GILA AND SALT RIVER MERIDIAN, MARICOPA COUNTY, ARIZONA.

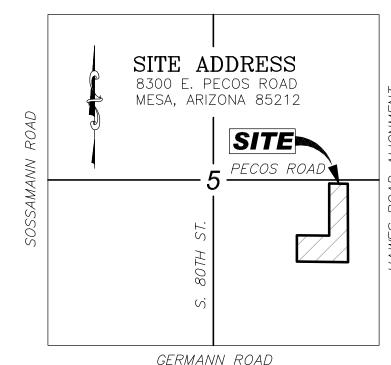

T.2S, R.7E

VICINITY MAP NOT TO SCALE

LEGAL DESCRIPTION

ABILITIES FOR FUTURE EXPANSION.

CONSTRUCTION OF A NEW OFFICE AND

DAVID TIDWELL

480.497.3140

501 E. COMSTOCK DR CHANDLER, AZ 85225

A PORTION OF THE EAST HALF OF THE SOUTHEAST QUARTER OF SECTION 5, TOWNSHIP 2 SOUTH, RANGE 7 EAST OF THE GILA AND SALT RIVER BASE AND MERIDIAN, MARICOPA COUNTY, ARIZONA, MORE PARTICULARLY DESCRIBED AS FOLLOWS:

COMMENCING AT THE EAST QUARTER CORNER OF SAID SECTION 5, BEING A CITY OF MESA BRASS CAP IN HANDHOLE, FROM WHICH THE SOUTHEAST CORNER OF SAID SECTION 5, BEING A BRASS CAP FLUSH BEARS SOUTH 00 DEGREES 35 MINUTES 30 SECONDS EAST, FOR A DISTANCE OF 2656.53 FEET;

THENCE NORTH 89 DEGREES 44 MINUTES 32 SECONDS WEST, ALONG THE NORTH LINE OF THE SOUTHEAST QUARTER OF SAID SECTION 5, FOR A DISTANCE OF 799.26 FEET, TO A POINT ON THE EAST LINE OF THE WEST 518.00 FEET OF THE NORTHEAST QUARTER OF THE SOUTHEAST QUARTER OF SAID SECTION 5;

THENCE SOUTH 00 DEGREES 37 MINUTES 43 SECONDS EAST, ALONG SAID EAST LINE, FOR A DISTANCE OF 65.01 FEET, TO A POINT ON THE SOUTH RIGHT OF WAY LINE OF PECOS ROAD AS RECORDED IN INSTRUMENT NO. 2001-0366203, RECORDS OF MARICOPA COUNTY, ARIZONA AND THE POINT OF BEGINNING;

THENCE SOUTH 89 DEGREES 44 MINUTES 32 SECONDS EAST, ALONG SAID RIGHT OF WAY, FOR A DISTANCE OF 330.04 FEET TO A POINT ON THE EAST LINE OF THE WEST 848.00 FEET OF THE NORTHEAST QUARTER OF THE SOUTHEAST QUARTER OF SAID

THENCE SOUTH OO DEGREES 37 MINUTES 43 SECONDS EAST, ALONG SAID EAST LINE, FOR A DISTANCE OF 1263.60 FEET;

THENCE NORTH 89 DEGREES 46 MINUTES 53 SECONDS WEST, FOR A DISTANCE OF 848.09 FEET TO A POINT ON THE WEST LINE OF THE NORTHEAST QUARTER OF THE SOUTHEAST QUARTER OF SAID SECTION 5;

THENCE NORTH 00 DEGREES 37 MINUTES 43 SECONDS WEST, ALONG SAID WEST LINE, FOR A DISTANCE OF 423.08 FEET TO A POINT ON THE SOUTH LINE OF THE NORTH 841.00 FEET OF THE NORTHEAST QUARTER OF THE SOUTHEAST QUARTER OF SAID

THENCE SOUTH 89 DEGREES 44 MINUTES 32 SECONDS EAST, ALONG SAID SOUTH LINE, FOR A DISTANCE OF 518.06 FEET TO A POINT ON THE EAST LINE OF THE WEST 518.00 FEET OF THE NORTHEAST QUARTER OF THE SOUTHEAST QUARTER OF SAID SECTION 5;

THENCE NORTH 00 DEGREES 37 MINUTES 43 SECONDS WEST, ALONG SAID EAST LINE, FOR A DISTANCE OF 841.10 FEET TO A POINT ON THE SOUTH RIGHT OF WAY LINE OF PECOS ROAD AS RECORDED IN INSTRUMENT NO. 2001-0366203, RECORDS OF MARICOPA COUNTY, ARIZONA AND THE POINT OF BEGINNING.

* THIS LEGAL DESCRIPTION DOES NOT REFLECT THE LEGAL DESCRIPTION SHOWN ON THE TITLE COMMITMENT REFERENCED HEREON. THIS LEGAL OF THE SUBJECT PROPERTY IS ONLY A PORTION OF PARCEL 1 ON THE TITLE COMMITMENT.

PARCEL NU. 2: (]AX PARCEL NU. 304-61-012 R)
THE NURTH 30.00 FEET UF THE EAST 802.08 FEET UF THE SUUTHEAST QUARTER UF THE SUUTHEAST QUARTER SECTION 5, TOWNSHIP 2 SOUTH, RANGE 7 EAST OF THE GILA AND

SITE AREA

PARCEL 1 NET AREA - 636,086 SQ.FT. OR 14.603 ACRES PARCEL 1 GROSS AREA - 657,571 SQ.FT. OR 15.096 ACRES ONSITE DISTURBED AREA - 276,721 SQ.FT. OR 6.353 ACRES

SALI RIVER BASE AND MERIDIAN, MARICUPA CUUNIY, ARIZUNA.

BENCHMARK

A BRASS TAG IN THE NOWTHWEST CORNER IN BRIDGE AT THE INTERSECTION OF SOSSAMAN ROAD AND GERMANN

ELEV = 1356.84 (NAVD'88)

BASIS OF BEARING

THE NORTH LINE OF THE SOUTHEAST QUARTER OF SECTION 5, TOWNSHIP 2 SOUTH, RANGE 7 EAST, BEARS NORTH 89 DEGREES 44 MINUTES 32 SECONDS WEST.

ZONING

ZONING LI-LIGHT INDUSTRIAL

FLOOD ZONE (FIRM)

ACCORDING TO FIRM FLOOD INSURANCE RATE MAP NO. 04013C2770L DATED OCTOBER 16, 2013, THE SUBJECT PROPERTY IS LOCATED IN ZONE SHADED X. ZONE SHADED X IS DESCRIBED AS: "AREAS OF 0.2% ANNUAL CHANCE FLOOD; AREAS OF 1% ANNUAL CHANCE FLOOD WITH AVERAGE DEPTHS OF LESS THAN 1 FOOT OR WITH DRAINAGE AREAS LESS THAN 1 SQUARE MILE; AND AREAS PROTECTED BY LEVEES FROM 1% ANNUAL CHANCE FLOOD."

ASSESSOR'S PARCEL NUMBER

149-24-001R




CHARLES G **%,4-28-17**.

DATE: MARCH 201 DRAWING NO.

TRUE NORTH

C1.0 OF 2

J□B: 0080

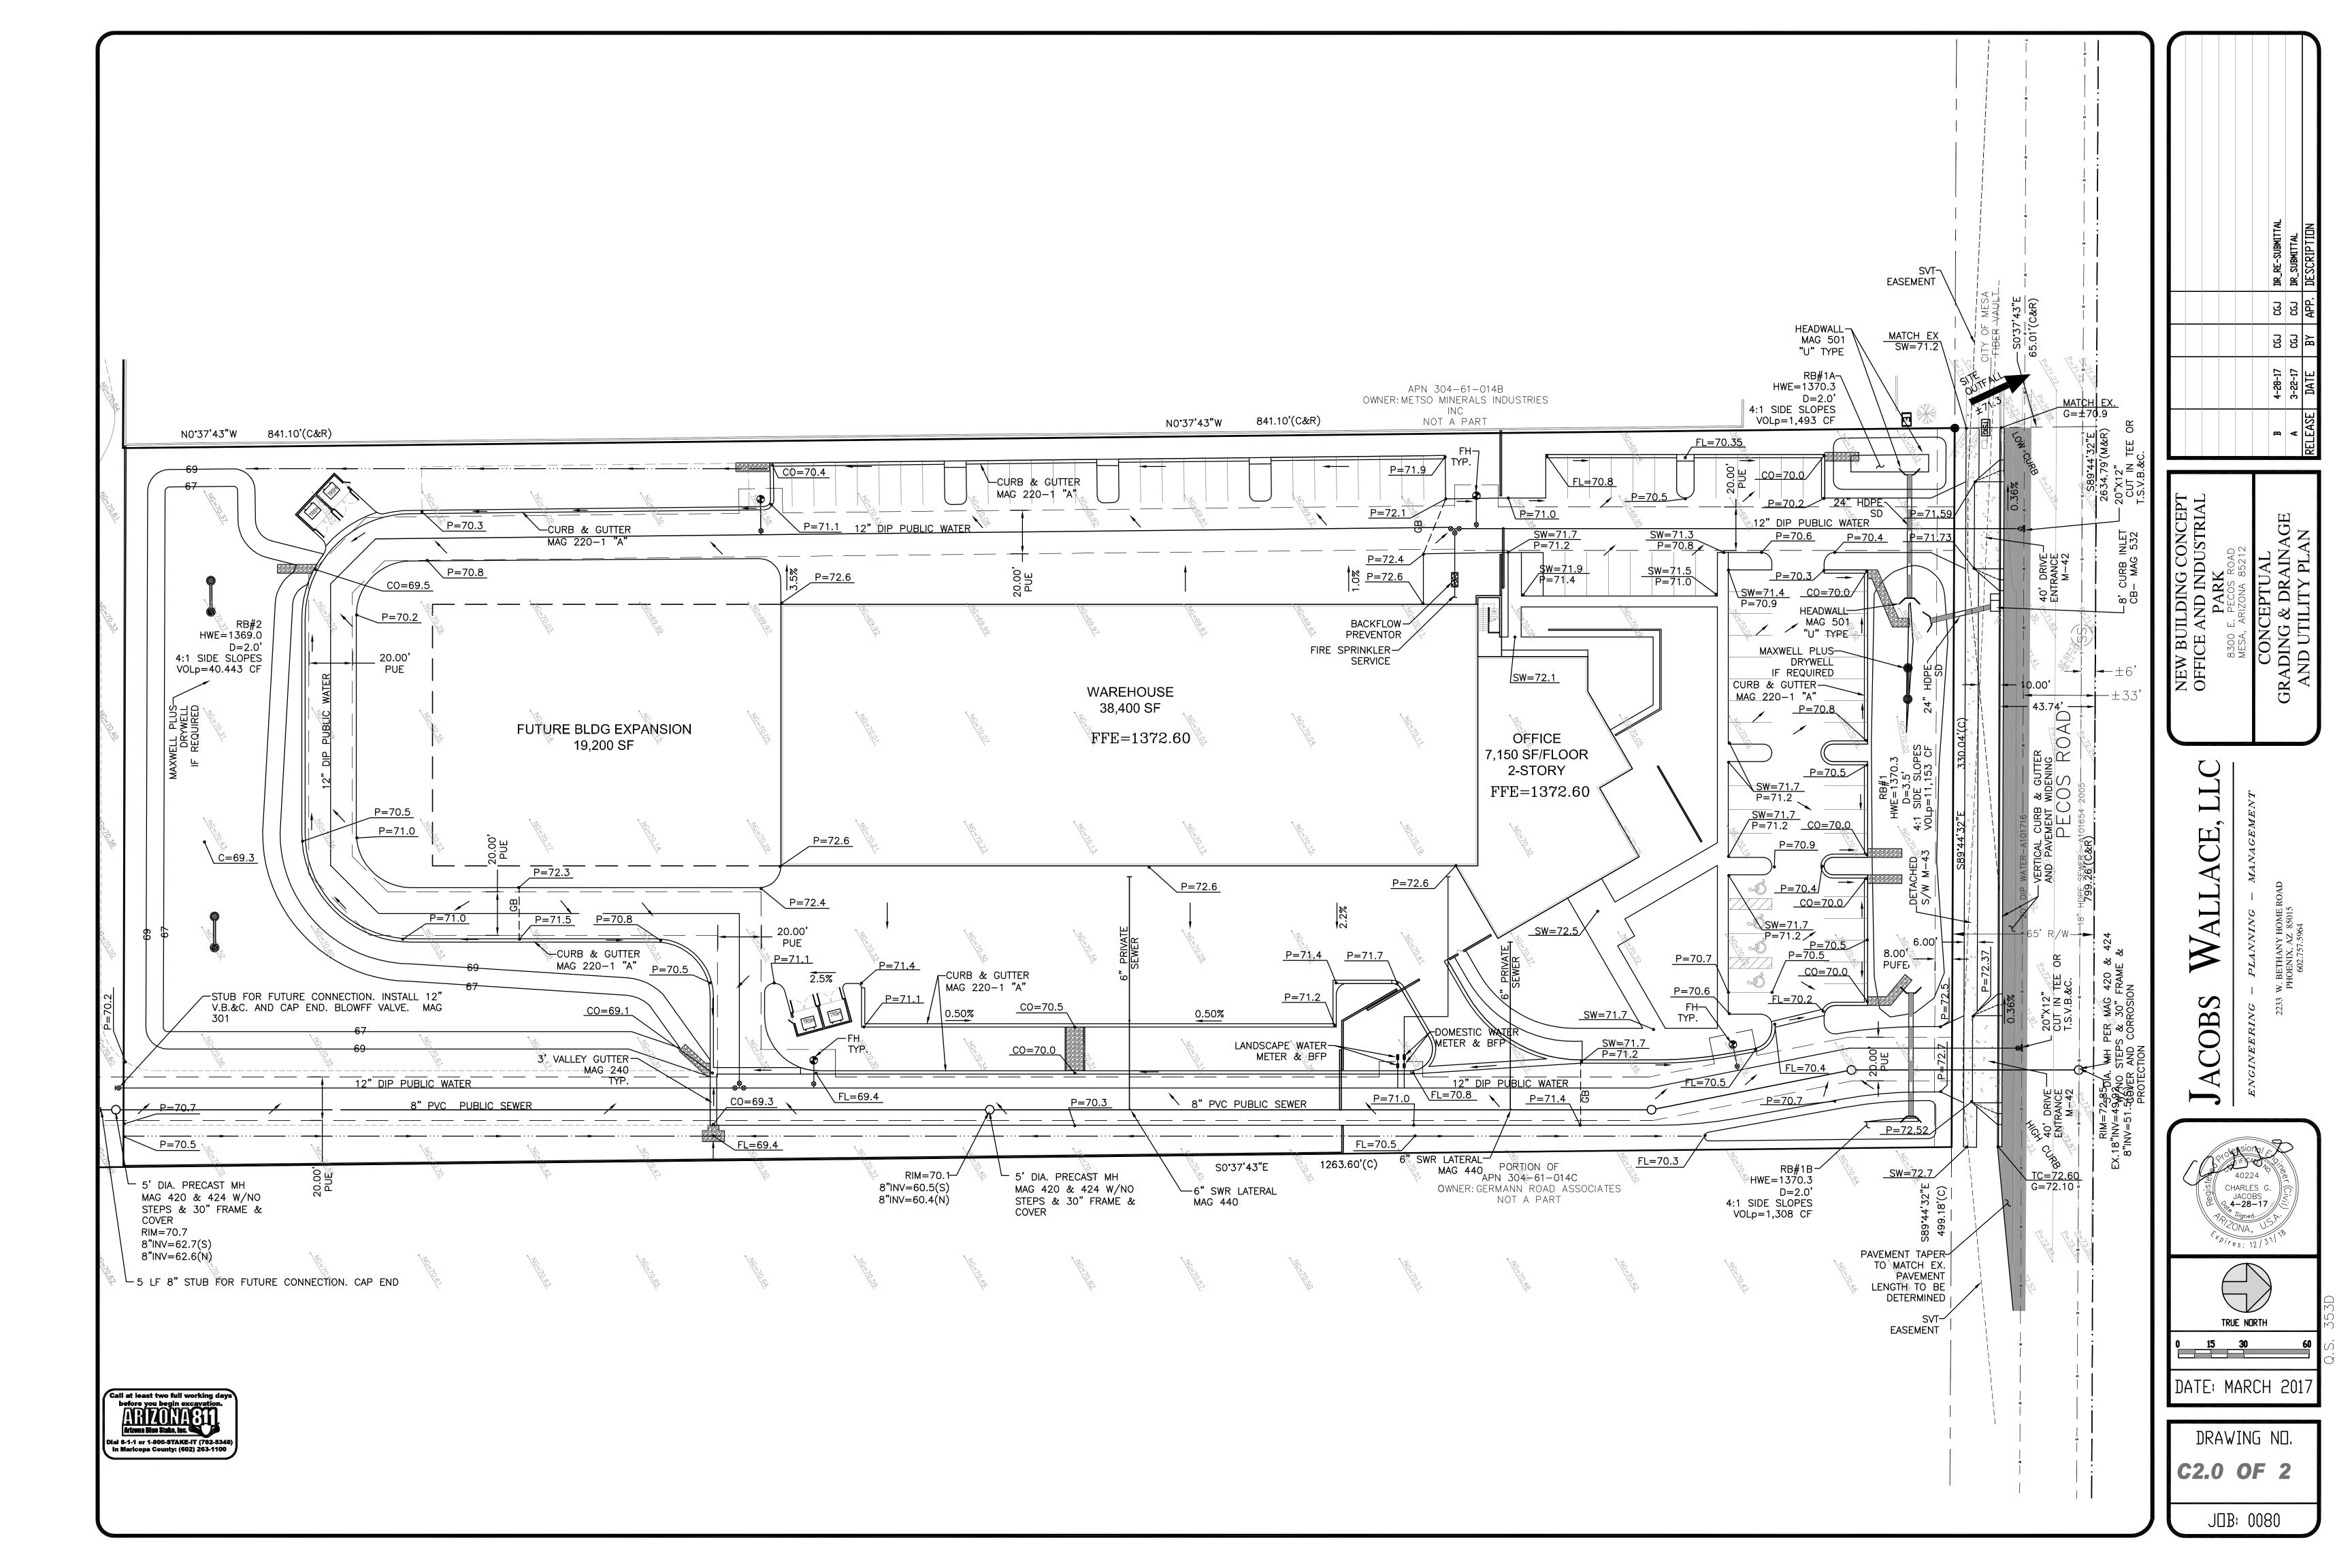

CONCEPTUAL PLANT PALETTE

		· / \—— · · —
	TREES	SIZE/COMMENTS
	CERCIDIUM PRAECOX AZT HYBRID #5 AZT HYBRID PALO BREA #5	36" BOX / LOW BREAKING 8 QTY
$\left(\cdot\right)$	PROSOPIS 'AZT' HYBRID 'AZT HYBRID' MESQUITE	24" BOX / LOW BREAKING 34 QTY
	ACACIA FARNESIANA SWEET ACACIA	24" BOX / LOW BREAKING 14 QTY
	SHRUBS	SIZE/COMMENTS
•	TRACHELOSPERMUM ASIATICUM ASIATIC JASMINE	5 GAL/ 35 QTY
G	LEUCOPHYLLUM ZYGOPHYLLUM CIMARRON SAGE	5 GAL/ 34 QTY
*	HESPERALOE PARVIFLORA	5 GAL/ 18 QTY

	RED YUCCA	
•	LEUCOPHYLLUM LANGMANIAE RIO BRAVO SAGE	5 GAL/ 88 QTY
<u>-</u>	RUELLIA PENINSULARIS BAJA RUELLIA	5 GAL/ 86 QTY

	BAJA RUELLIA	
	GROUNDCOVER	SIZE/COMMENTS
0 0	ERICAMERIA LARICIFOLIA 'AGUIRRE' TURPENTINE	1 GAL / 142 QTY
A	LANTANA 'NEW GOLD' TRAILING YELLOW LANTANA	1 GAL @ 3' O.C. 188 QTY
B	ROSMARINUS 'HUNTINGTON CARPET' TRAILING ROSEMARY	1 GAL @ 3' O.C. 266 QTY
<u>C</u>	JUSTICIA CALIFORNICA CHUPAROSA	1 GAL @ 3' O.C. 52 QTY
\bigcirc D	RUELLIA BRITTONIANA 'BLANCA' WHITE DWARF RUELLIA	1 GAL @ 2.5' O.C 298 QTY
E	ENCILIA FARINOSA BRITTLE BUSH	1 GAL @ 4' O.C. 130 QTY
DG	DECOMPOSED GRANITE GRANITE EXPRESS ARIZONA GOLD	1/4" MINUS 2" DEPTH TYP.
DG1	DECOMPOSED GRANITE GRANITE EXPRESS BROWN	1/4" MINUS 2" DEPTH TYP.
FG	FRACTURED GRANITE	1"-3"

4" DEPTH TYP.

GENERAL NOTES

ALL PLANTING AREAS TO HAVE TOP DRESSING OF DECOMPOSED GRANITE, SIZE AND COLOR AS CALLED FOR, 2" THICK, TYP. APPLIED OVER PRE-EMERGENT PER MFG. SPECS, 2 APPLICATIONS, MIN.

GRANITE EXPRESS ARIZONA GOLD

VERIFY ALL CONDITIONS IN FIELD PRIOR TO BIDDING/ INSTALLATION. DISCREPANCIES SHALL BE BROUGHT TO THE LANDSCAPE ARCHITECT'S ATTENTION, IN WRITING

NO PLANT SUBSTITUTION ALLOWED UNLESS APPROVED BY LANDSCAPE ARCHITECT.

LANDSCAPE ARCHITECT TO APPROVE ALL TREES AND SHRUBS PRIOR TO DELIVERY TO SITE. LANDSCAPE ARCHITECT OR HIS REP RESERVE THE RIGHT

TO REFUSE ANY PLANT HE/SHE DEEMS UNACCEPTABLE. FOR CLARIFICATION OF DISCREPANCIES BETWEEN THE DWGS AND THE SITE, THEY SHOULD BE BROUGHT TO THE ATTENTION OF THE LANDSCAPE ARCHITECT PRIOR TO BEGINNING WORK.

LANDSCAPE CONTRACTOR IS RESPONSIBLE TO TAKE PRECAUTIONS TO PROTECT ANY EXISTING IMPROVEMENTS. PLANT LIST/QTY'S PROVIDED FOR CONTRACTOR'S CONVENIENCE

ONLY. PLANS TAKE PRECEDENCE. FINISHED GRADE BELOW ALL PLANTERS SHALL BE 1" BELOW ADJACENT HEADER, PAVING, CURBING, ETC.

GROUNDCOVER AND/OR DG SHALL EXTEND UNDER SHRUBS UNLESS NOTED.

ALL EARTHWORK IS TO BE DONE SO THAT ALL WATER DRAINS AWAY FROM ALL STRUCTURES. 12. ALL UNDERGROUND CONDUITS/PIPES/UTLITIES ARE TO BE

LOCATED PRIOR TO DIGGING. ALL MATERIAL TO BE GUARANTEED PER WARRANTY.

CONTRACTOR IS RESPONSIBLE FOR ALL REQUIRED SLEEVING WHETHER IT IS SHOWN ON THE PLANS OR NOT. ADJUST NEW LANDSCAPE TO ACCOMMODATE EXISTING

LANDSCAPE TO REMAIN. LANDSCAPE CONTRACTOR RESPONSIBLE TO MAINTAIN EXISTING PLANT MATERIAL TO REMAIN IN GOOD, HEALTHY CONDITION DURING CONSTRUCTION.

17. ALL STEEL HEADER TO BE 1/8" COLD ROLLED STEEL.

CITY NOTES:

ALL EXISTING VEGETATION, WEEDS, DEBRIS, ETC..., ARE TO BE REMOVED FROM THE PROJECT AREA AND DISPOSED OF PROPERLY OFFSITE AT THE CONTRACTOR'S EXPENSE. THE CONTRACTOR SHALL THEN SCARIFY EXISTING SUBGRADE, TO A MINIMUM 8-INCH DEPTH.

SOIL TEST FOR FERTILITY AND ADDITIVE RECOMMENDATIONS (FOR TURF AND ORNAMENTALS) SHALL BE MADE SEVEN (7) DAYS PRIOR TO ANTICIPATED PLANTING TO DETERMINE IF ADDITIVES ARE REQUIRED. CONTRACTOR SHALL PROVIDE AND INCORPORATE SUCH ADDITIVES PRIOR TO OR AT THE TIME OF PLANTING.

3. CONTRACTOR SHALL STAKE TREE AND SHRUB LOCATIONS FOR 5-GALLON PLANTS AND LARGER. STAKES SHALL BE MARKED WITH PLANT NAME OR PLANT NAME OF PLANT LEGEND ITEM NUMBER FROM PLANS.

CONTRACTOR SHALL NOTIFY CITY ENGINEERING DIVISION (480-644-2253) 24-HOURS IN ADVANCE FOR APPROVAL OF STAKED PLANT LOCATIONS.

PLANT PITS MUST BE INSPECTED BY CITY LANDSCAPE INSPECTOR PRIOR TO PLANTING BY CONTRACTOR. CONTRACTOR TO REQUEST INSPECTION 48-HOURS IN ADVANCE.

6. WHERE CALICHE IS ENCOUNTERED IN PLANT PITS, DEPTH AND WIDTH OF PIT SHALL BE INCREASED BY (1/3) ONE-THIRD OVER SPECIFICATION, AND A LIQUID PENETRATE, "AL-KALICHE" OR APPROVED EQUAL SHALL BE INCORPORATED FOR EACH PIT PER MANUFACTURER'S RECOMMENDATIONS. CONTRACTOR SHALL ALSO COMPLY WITH SOIL TEST RECOMMENDATIONS.

ALL TOP SOIL MIXTURE FOR PLANTS SHALL BE FREE OF GRASS AND NOXIOUS WEEDS. SEE SECTION 795 OF THE M.A.G. SPECIFICATIONS.

PLANT SOIL MIXTURE SHALL CONSIST OF 3 1/2-PARTS NATURAL FERTILE, FRIABLE SOIL AND ONE PART HUMUS BY VOLUME, THOROUGHLY MIXED PRIOR TO BACKFILLING IN PITS. BACKFILLING SHALL BE IN 6-INCH LIFTS. EACH LIFT SHALL BE WATER SETTLED, WITHOUT PUDDLING

ALL PLANT MATERIAL SHALL CONFORM TO GRADING, TYPE, ETC..., AS SET FORTH IN THE AMERICAN ASSOCIATION OF NURSERYMEN AND BY THE ARIZONA NURSERY ASSOCIATION RECOMMENDED TREE SPECIFICATIONS.

10. THE CITY OF MESA RESERVES THE RIGHT TO INSPECT SHRUBS AND CONTAINER TREES FOR CONDITION OF ROOT BALLS. FOR ANY SUCH INSPECTIONS FOR CONDITIONS WHICH MAY DESTROY ROOT BALL, CONTRACTOR SHALL SUPPLY ADDITIONAL PLANT AT NO COST

11. 120 VOLT POWER FOR SPRINKLER SYSTEM CONTROLLER IS TO BE ORDERED FROM APPROPRIATE POWER UTILITY BY CONTRACTOR. CONTRACTOR ACTS AS OWNER AND PAYS RELATED COSTS. IF METER IS INSTALLED, METER IS TO BE IN CONTRACTOR'S NAME UNTIL FINAL APPROVAL AND/OR ACCEPTANCE OF THE PROJECT AND THEN TRANSFERED TO THE MAINTAINING PARTY.

12. THE CONTRACTOR SHALL PROVIDE ALL THE MATERIALS AND LABOR NECESSARY TO INSTALL THE COMPLETE AUTOMATIC SPRINKLER SYSTEM INCLUDING THE WATER SERVICE AND METER. THE CONTRACTOR SHALL ORDER THE WATER METER AND PAY ALL RELATED CHARGES AT THE PUBLIC WORKS SERVICES. THE CITY MAY INSTALL THE WATER SERVICE AND METER AND CHARGE THE CONTRACTOR AT THE CITY'S DISCRETION.

13. THE PLANT GUARANTEE AND MAINTENANCE SHALL BE AS PER SECTION 430.8 OF M.A.G. SPECIFICATIONS UNTIL PROJECT APPROVAL AND/OR ACCEPTANCE.

14. UNLESS SPECIFIED ON THE PLANS FOR REMOVAL, THE CONTRACTOR SHALL BE RESPONSIBLE FOR:

1. DAMAGES TO EXISTING WALKS, WALLS, DRIVES, CURBS, ETC... 2. DAMAGES TO UTILITIES CAUSED AS A RESULT OF HIS WORK.

3. INSPECTING THE SITE IN ORDER TO BE FULLY AWARE OF EXISTING CONDITIONS PRIOR TO SUBMITTING BID.

15. THE CONTRACTOR SHALL MAINTAIN UNCOVERED, ALL EXISTING UTILITY COVERS, BOXES, LIDS, AND MANHOLES. 16. ALL EQUIPMENT AND MATERIALS NOT SHOWN OR SPECIFIED IN THE PLANS OR IN THE SPECIFICATION WHICH ARE

REQUIRED TO COMPLETE THE INSTALLATION, SHALL BE SUPPLIED BY THE CONTRACTOR AS PART OF HIS CONTRACT

PLANT CALCULATIONS:

PLANI CALCUL	AHONS.			
	15 GAL	24" BO	X	36" BOX
TREE SIZE RATIO TOTAL TREES: 56	0 QTY 0%	48 QTY 85%	′	8 QTY 15%
	TREES REQ / PRO	VIDED S	HRUB	S REQ / PROVIDED
STREET FRONTAGE REQUIREMENTS 1 TREE/ 6 SHRUB PER 25 L.F.	10 TREES / 10 TR	REES	60 SHR	RUBS / 70 SHRUBS
PARKING LOT REQUIREMENTS 1 TREE / 3 SHRUB PER ISLAND	16 TREES / 16 TI	REES	48 SHF	RUBS / 78 SHRUBS
FOUNDATION PLANTING REQUIREMENTS 1 TREE PER 50 L.F.	8 TREES / 9 TR	EES	87 SH	RUBS PROVIDED

NOTES:

-REQUIRED TREES SHALL BE MINIMUM SIZE AS SPECIFIED IN THE ARIZONA NURSERY ASSOCIATION "RECOMMENDED TREE SPECIFICATIONS" LATEST EDITION

-ALL LANDSCAPE MATERIAL INSTALLED SHALL BE MAINTAINED BY OWNER / OR LESSEE IN ACCORDANCE WITH THE APPROVED LANDSCAPE PLAN.

-A NATURAL LANDSCAPE MAINTENANCE PROGRAM SHALL BE MAINTAINED IN ACCORDANCE WITH THE BEST MANAGEMENT PRACTICE OF THE LANDSCAPING INDUSTRY.


-ALL TREES AND SHRUBS LOCATED IN THE LINE OF SIGHT WILL BE MAINTAINED FOR A CLEAR AREA BETWEEN 3' AND 7'. LINE OF SIGHT SHOWN ON PLANS.

-REQUIRED LANDSCAPING AREAS SHALL BE FREE FROM ENCROACHMENT BY ANY USE, STRUCTURE, OR VEHICLE OR FEATURE NOT A PART OF THE LANDSCAPE DESIGN.


-BACKFLOW PREVENTERS 2" OR LARGER SHALL BE SCREENED WITH LANDSCAPE MATERIAL LOCATED WITHIN A 6' RADIUS OF THE BACKFLOW PREVENTERS. ALL BACKFLOW PREVENTERS LESS THAN 2" SHALL BE PLACED IN A WIRE MESH BASKET.



4th 602 602

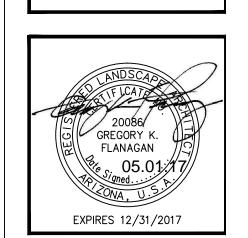

revisions:		
date: 05.0	01.17	
contents:	COVER SHEET	
sheet no.		
L-	- 0	

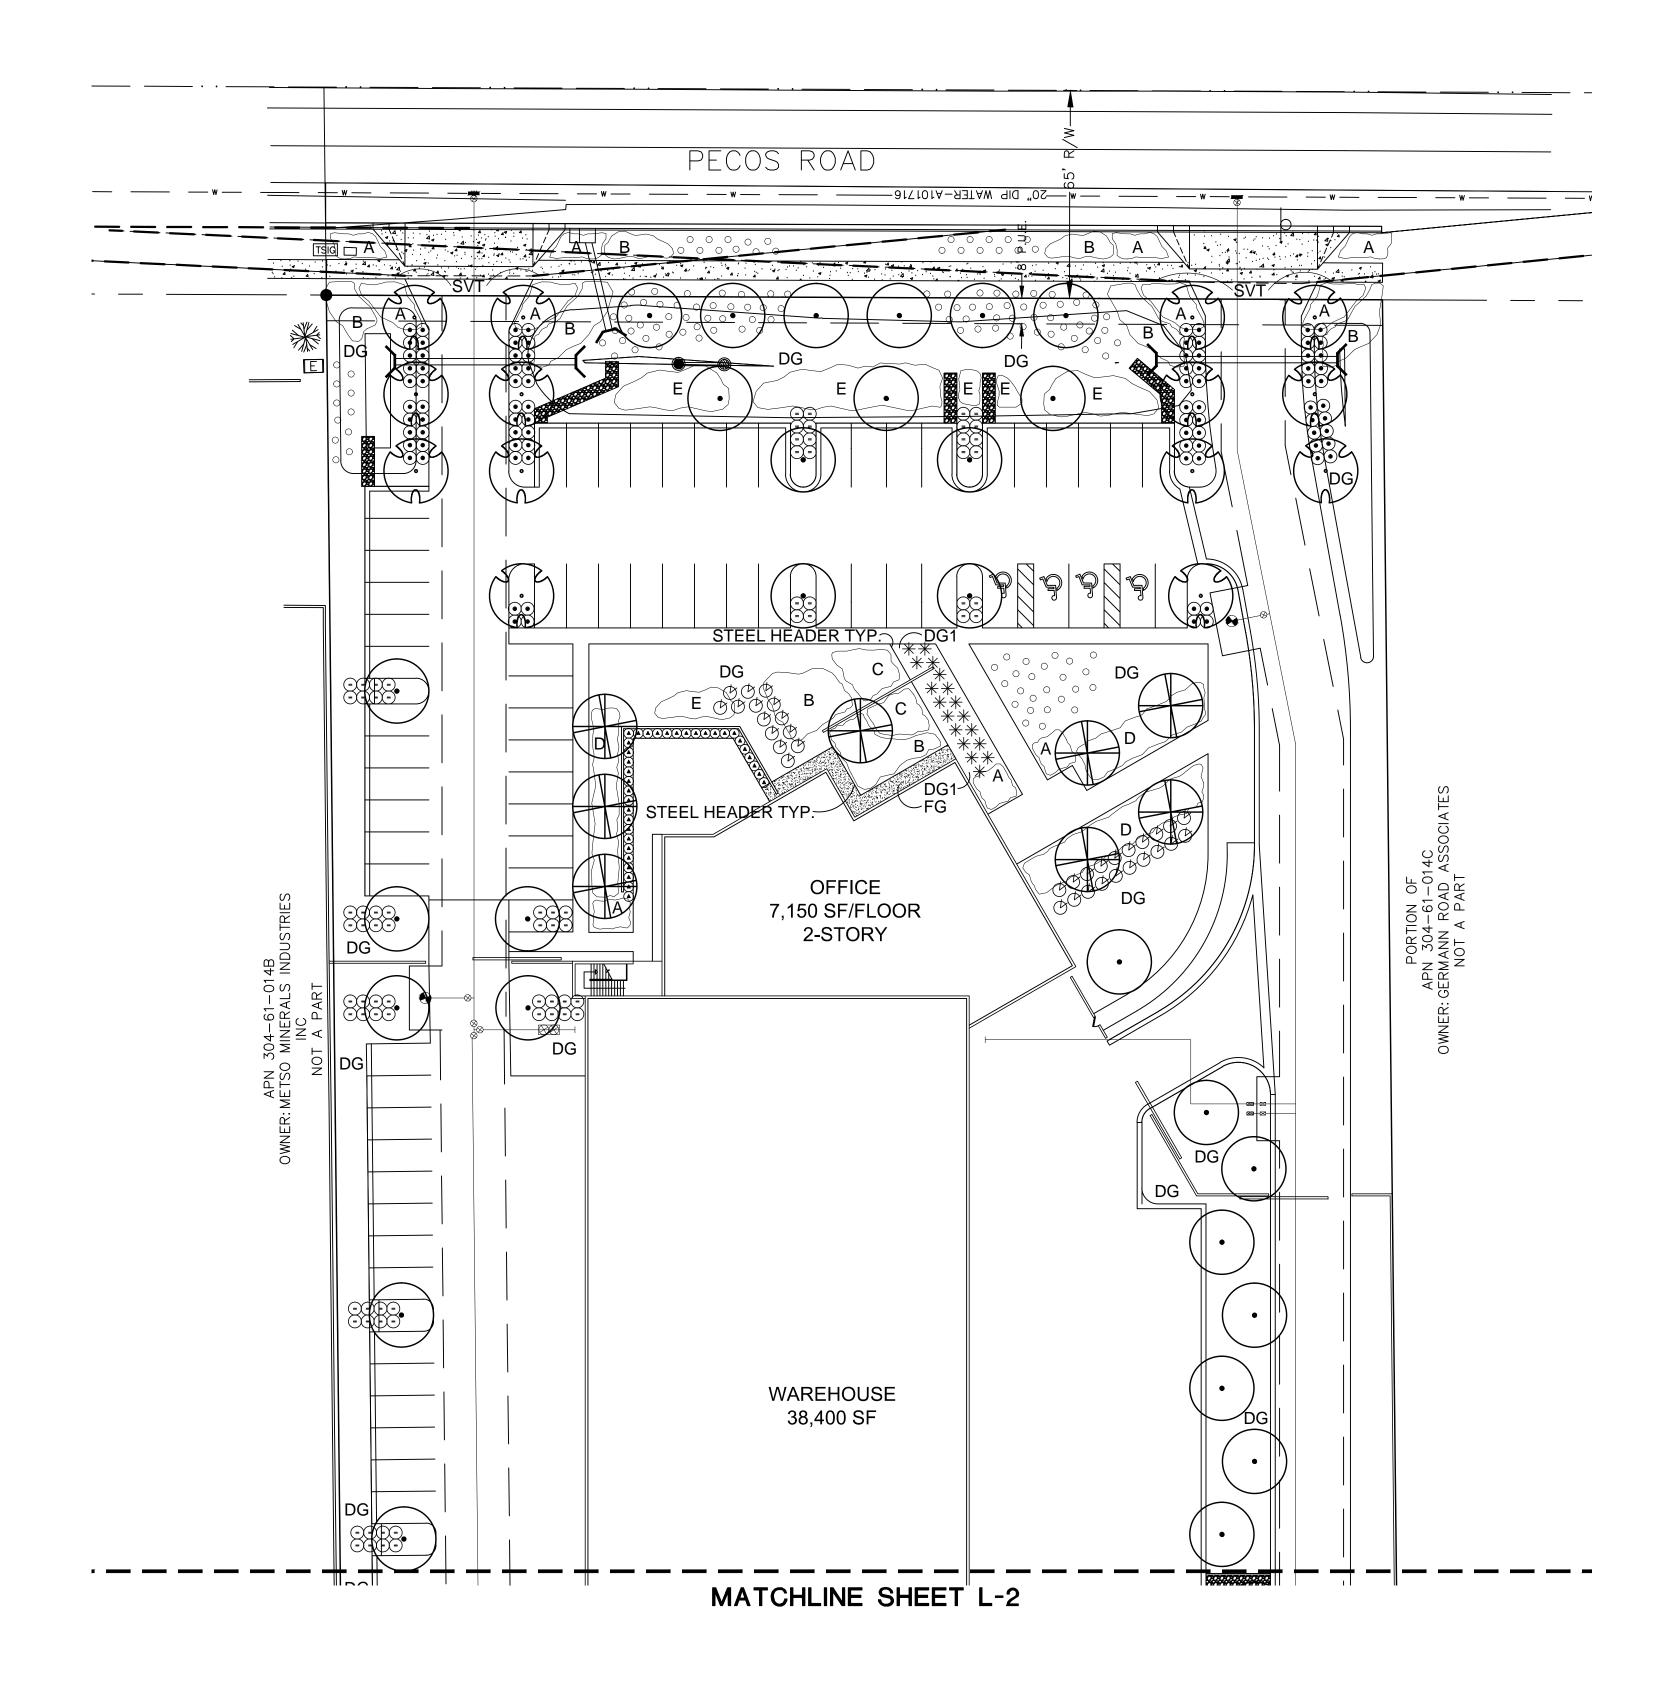

CONCEPTUAL PLANTING PLAN SCALE: 1"=30'-0" Ref. North

CONCEPTUAL PLANT PALETTE

	TREES	SIZE/COMMENTS
	CERCIDIUM PRAECOX AZT HYBRID #5 AZT HYBRID PALO BREA #5	36" BOX / LOW BREAKING 8 QTY
	PROSOPIS 'AZT' HYBRID 'AZT HYBRID' MESQUITE	24" BOX / LOW BREAKING 34 QTY
	ACACIA FARNESIANA SWEET ACACIA	24" BOX / LOW BREAKING 14 QTY
	SHRUBS	SIZE/COMMENTS
•	TRACHELOSPERMUM ASIATICUM ASIATIC JASMINE	5 GAL/ 35 QTY
O	LEUCOPHYLLUM ZYGOPHYLLUM CIMARRON SAGE	5 GAL/ 34 QTY
*	HESPERALOE PARVIFLORA RED YUCCA	5 GAL/ 18 QTY
•	LEUCOPHYLLUM LANGMANIAE RIO BRAVO SAGE	5 GAL/ 88 QTY
-	RUELLIA PENINSULARIS BAJA RUELLIA	5 GAL/ 86 QTY
0	GROUNDCOVER ERICAMERIA LARICIFOLIA 'AGUIRRE' TURPENTINE	SIZE/COMMENTS 1 GAL / 142 QTY
A	LANTANA 'NEW GOLD' TRAILING YELLOW LANTANA	1 GAL @ 3' O.C. 188 QTY
B	ROSMARINUS 'HUNTINGTON CARPET' TRAILING ROSEMARY	1 GAL @ 3' O.C. 266 QTY
C	JUSTICIA CALIFORNICA CHUPAROSA	1 GAL @ 3' O.C. 52 QTY
D	RUELLIA BRITTONIANA 'BLANCA' WHITE DWARF RUELLIA	1 GAL @ 2.5' O.C. 298 QTY
E	ENCILIA FARINOSA BRITTLE BUSH	1 GAL @ 4' O.C. 130 QTY
DG	DECOMPOSED GRANITE GRANITE EXPRESS ARIZONA GOLD	1/4" MINUS 2" DEPTH TYP.
DG1	DECOMPOSED GRANITE GRANITE EXPRESS BROWN	1/4" MINUS 2" DEPTH TYP.
FG	FRACTURED GRANITE GRANITE EXPRESS ARIZONA GOLD	1"-3" 4" DEPTH TYP.

GENERAL NOTES

- 1. ALL PLANTING AREAS TO HAVE TOP DRESSING OF DECOMPOSED GRANITE, SIZE AND COLOR AS CALLED FOR, 2" THICK, TYP. APPLIED OVER PRE-EMERGENT PER MFG. SPECS, 2 APPLICATIONS, MIN.
- VERIFY ALL CONDITIONS IN FIELD PRIOR TO BIDDING/ INSTALLATION. DISCREPANCIES SHALL BE BROUGHT TO THE LANDSCAPE ARCHITECT'S ATTENTION, IN WRITING.
 NO PLANT SUBSTITUTION ALLOWED UNLESS APPROVED
- BY LANDSCAPE ARCHITECT.

 4. LANDSCAPE ARCHITECT TO APPROVE ALL TREES AND
- SHRUBS PRIOR TO DELIVERY TO SITE.

 5. LANDSCAPE ARCHITECT OR HIS REP RESERVE THE RIGHT TO REFUSE ANY PLANT HE/SHE DEEMS UNACCEPTABLE.
- 6. FOR CLARIFICATION OF DISCREPANCIES BETWEEN THE DWGS
 AND THE SITE, THEY SHOULD BE BROUGHT TO THE ATTENTION
 OF THE LANDSCAPE ARCHITECT PRIOR TO BEGINNING WORK.
- LANDSCAPE CONTRACTOR IS RESPONSIBLE TO TAKE
 PRECAUTIONS TO PROTECT ANY EXISTING IMPROVEMENTS.

 PLANT LIST/QTY'S PROVIDED FOR CONTRACTOR'S CONVENIENCE
- ONLY. PLANS TAKE PRECEDENCE.

 9. FINISHED GRADE BELOW ALL PLANTERS SHALL BE 1" BELOW
- ADJACENT HEADER, PAVING, CURBING, ETC.

 10. GROUNDCOVER AND/OR DG SHALL EXTEND UNDER SHRUBS UNLESS NOTED.
- 11. ALL EARTHWORK IS TO BE DONE SO THAT ALL WATER DRAINS AWAY FROM ALL STRUCTURES.
 12. ALL UNDERGROUND CONDUITS/PIPES/UTLITIES ARE TO BE
- LOCATED PRIOR TO DIGGING.

 13. ALL MATERIAL TO BE GUARANTEED PER WARRANTY.
- 14. CONTRACTOR IS RESPONSIBLE FOR ALL REQUIRED SLEEVING WHETHER IT IS SHOWN ON THE PLANS OR NOT.
 15. ADJUST NEW LANDSCAPE TO ACCOMMODATE EXISTING
- LANDSCAPE TO REMAIN.

 LANDSCAPE CONTRACTOR RESPONSIBLE TO MAINTAIN EXISTING PLANT MATERIAL TO REMAIN IN GOOD, HEALTHY CONDITION
- DURING CONSTRUCTION.


 17. ALL STEEL HEADER TO BE 1/8" COLD ROLLED STEEL.



COS RD.

8300 E. PECOS RI


ASSOCIATES, INC
LANDSCAPE ARCHITECTURE
PLANNING
1626 N. 44th STREET PHOENIX, AZ 85018
602 : 912 : 9691 tel
602 : 912 : 9693 fax

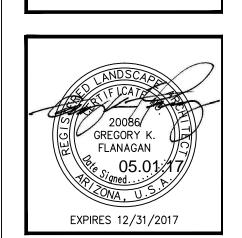

date: 05.01.17

contents: PLANTING PLAN
sheet no.

L—1

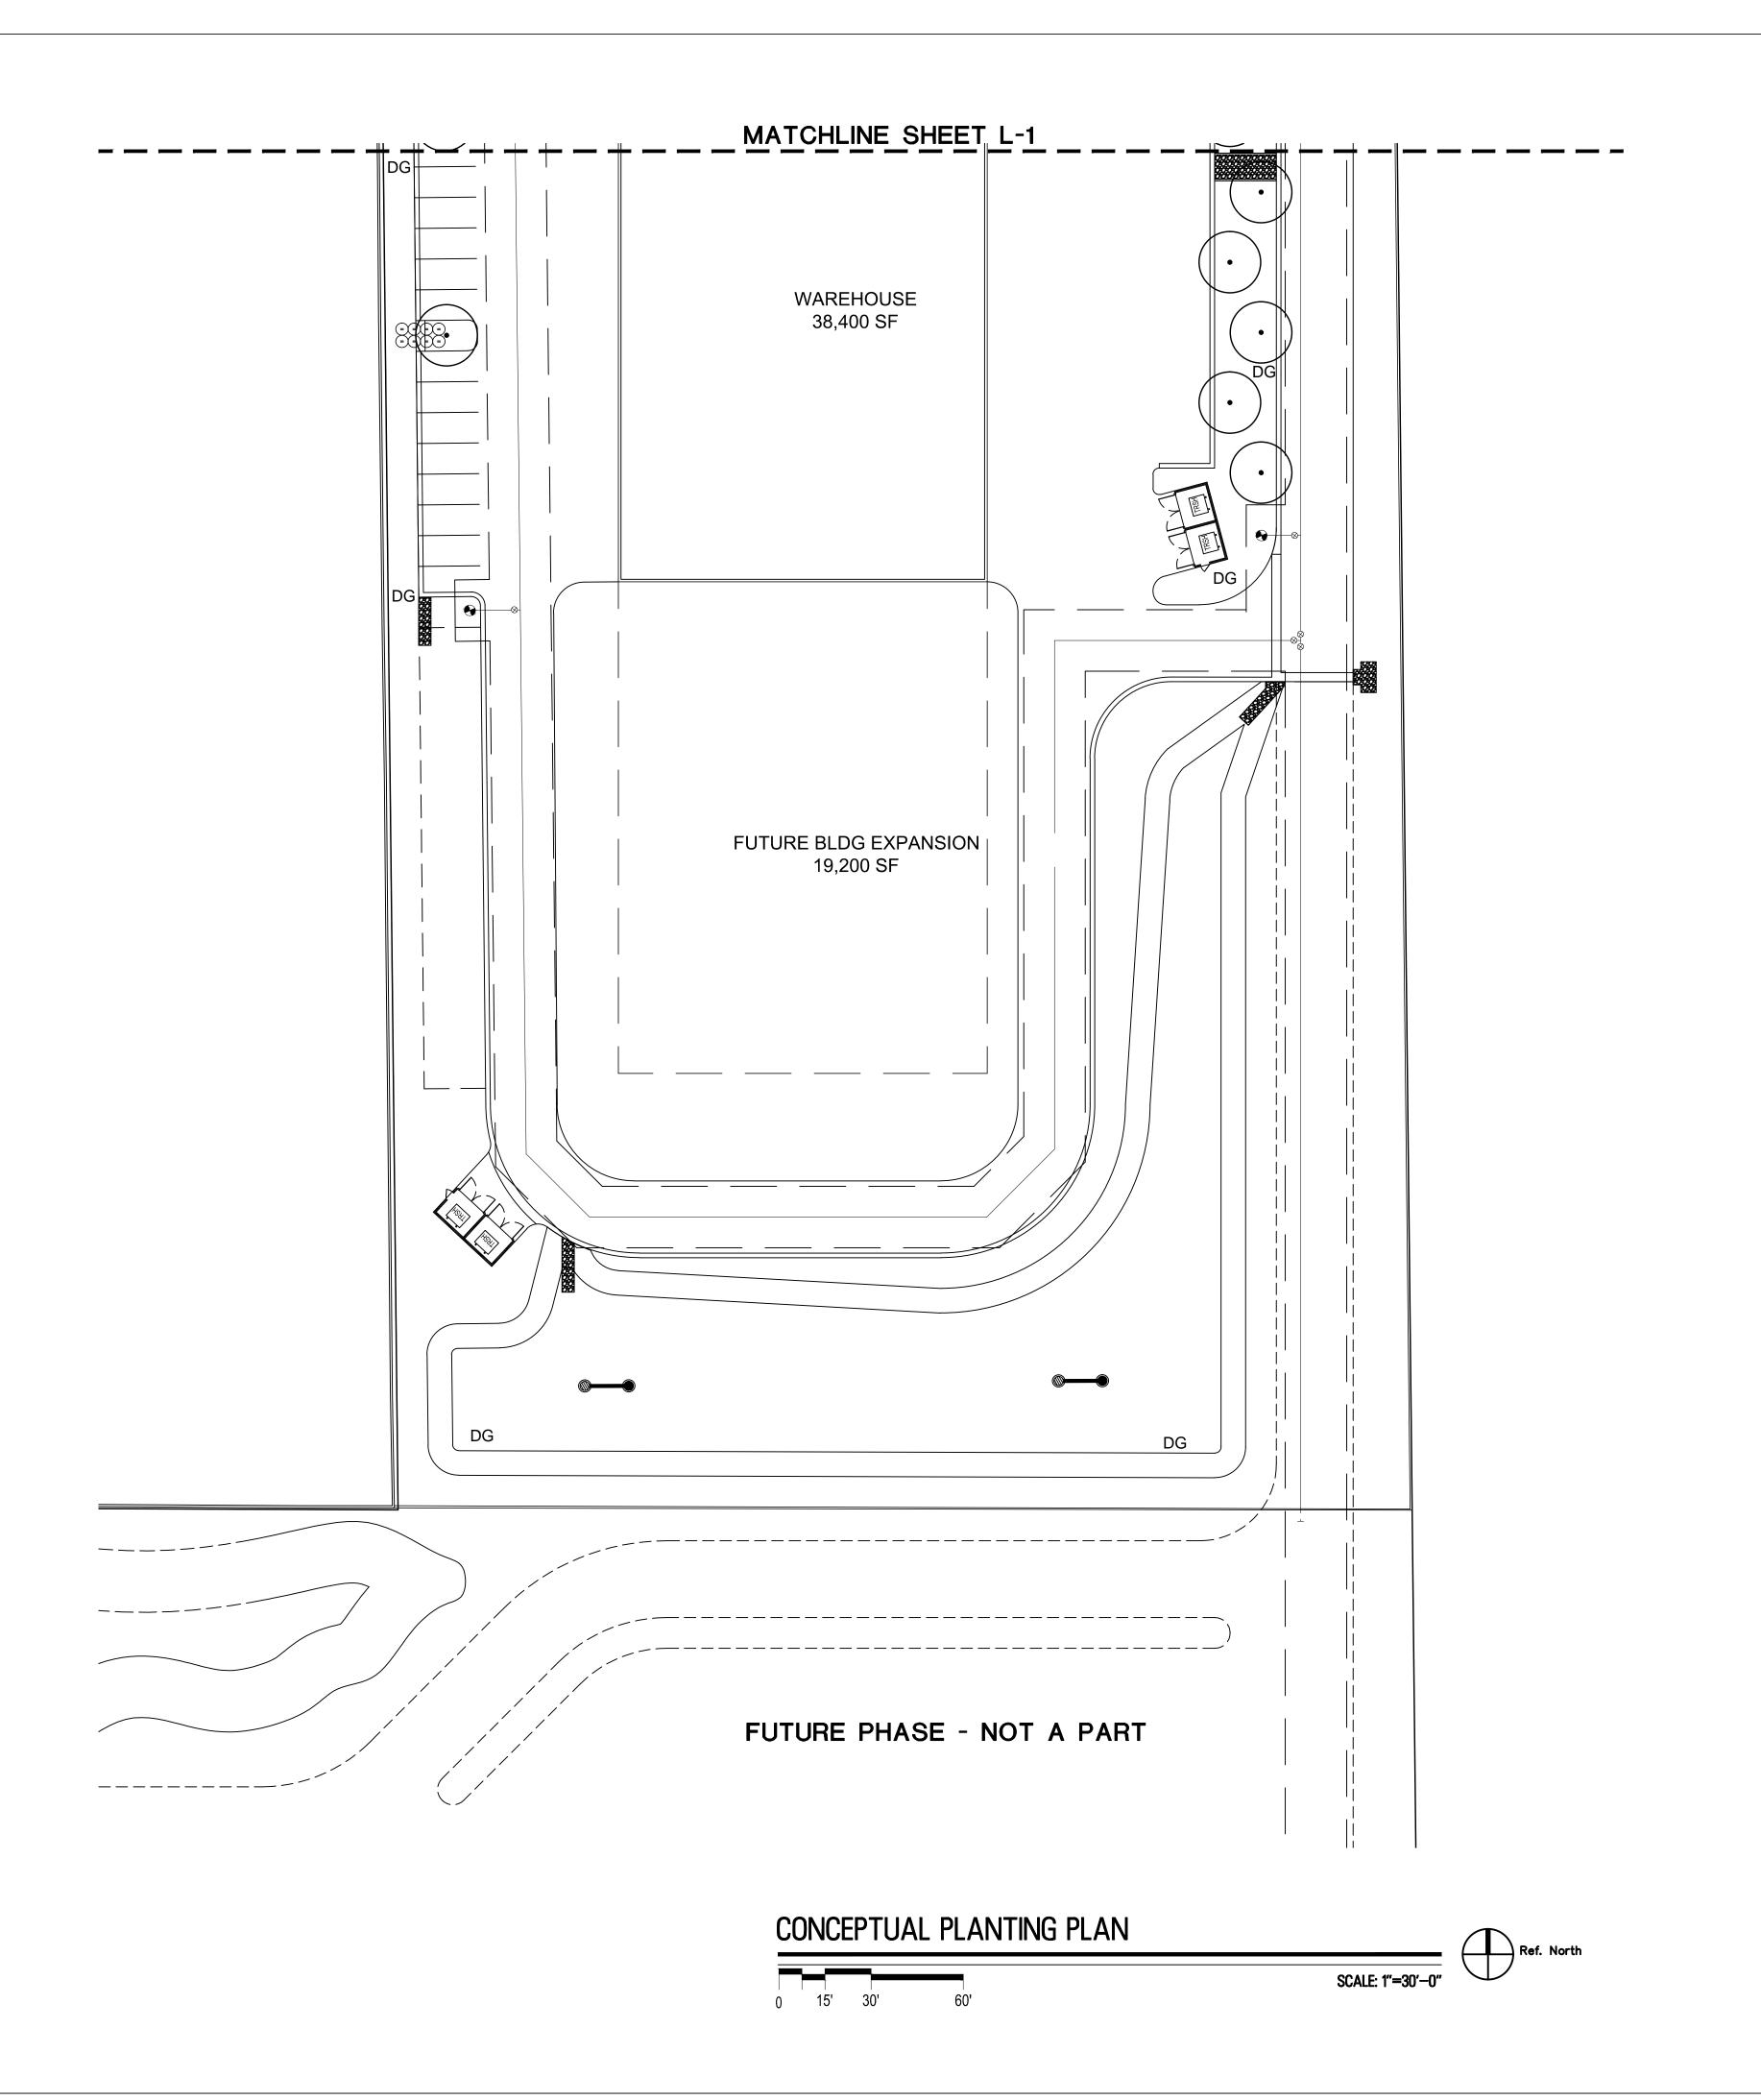

CONCEPTUAL PLANT PALETTE

SIZE/COMMENTS CERCIDIUM PRAECOX AZT HYBRID #5 36" BOX / LOW BREAKING AZT HYBRID PALO BREA #5 8 QTY PROSOPIS 'AZT' HYBRID 24" BOX / LOW BREAKING 'AZT HYBRID' MESQUITE 34 QTY ACACIA FARNESIANA 24" BOX / LOW BREAKING SWEET ACACIA 14 QTY SIZE/COMMENTS <u>SHRUBS</u> TRACHELOSPERMUM ASIATICUM 5 GAL/ 35 QTY **ASIATIC JASMINE** LEUCOPHYLLUM ZYGOPHYLLUM 5 GAL/ 34 QTY **CIMARRON SAGE** HESPERALOE PARVIFLORA 5 GAL/ 18 QTY RED YUCCA LEUCOPHYLLUM LANGMANIAE 5 GAL/ 88 QTY **RIO BRAVO SAGE** RUELLIA PENINSULARIS 5 GAL/ 86 QTY BAJA RUELLIA SIZE/COMMENTS GROUNDCOVER ERICAMERIA LARICIFOLIA 'AGUIRRE' 1 GAL / 142 QTY TURPENTINE LANTANA 'NEW GOLD' 1 GAL @ 3' O.C. TRAILING YELLOW LANTANA 188 QTY 1 GAL @ 3' O.C. **ROSMARINUS 'HUNTINGTON CARPET'** TRAILING ROSEMARY 266 QTY 1 GAL @ 3' O.C. JUSTICIA CALIFORNICA CHUPAROSA 52 QTY RUELLIA BRITTONIANA 'BLANCA' 1 GAL @ 2.5' O.C. WHITE DWARF RUELLIA 298 QTY **ENCILIA FARINOSA** 1 GAL @ 4' O.C. BRITTLE BUSH 130 QTY 1/4" MINUS DECOMPOSED GRANITE GRANITE EXPRESS ARIZONA GOLD 2" DEPTH TYP. 1/4" MINUS DECOMPOSED GRANITE **GRANITE EXPRESS BROWN** 2" DEPTH TYP.

GENERAL NOTES

FRACTURED GRANITE

ALL PLANTING AREAS TO HAVE TOP DRESSING OF DECOMPOSED GRANITE, SIZE AND COLOR AS CALLED FOR, 2" THICK, TYP. APPLIED OVER PRE-EMERGENT PER MFG. SPECS, 2 APPLICATIONS, MIN.

GRANITE EXPRESS ARIZONA GOLD


1"-3"

4" DEPTH TYP.

- VERIFY ALL CONDITIONS IN FIELD PRIOR TO BIDDING/ INSTALLATION. DISCREPANCIES SHALL BE BROUGHT TO THE LANDSCAPE ARCHITECT'S ATTENTION, IN WRITING.
- NO PLANT SUBSTITUTION ALLOWED UNLESS APPROVED BY LANDSCAPE ARCHITECT.
- LANDSCAPE ARCHITECT TO APPROVE ALL TREES AND SHRUBS PRIOR TO DELIVERY TO SITE. LANDSCAPE ARCHITECT OR HIS REP RESERVE THE RIGHT
- TO REFUSE ANY PLANT HE/SHE DEEMS UNACCEPTABLE. FOR CLARIFICATION OF DISCREPANCIES BETWEEN THE DWGS AND THE SITE, THEY SHOULD BE BROUGHT TO THE ATTENTION
- OF THE LANDSCAPE ARCHITECT PRIOR TO BEGINNING WORK. LANDSCAPE CONTRACTOR IS RESPONSIBLE TO TAKE PRECAUTIONS TO PROTECT ANY EXISTING IMPROVEMENTS.
- PLANT LIST/QTY'S PROVIDED FOR CONTRACTOR'S CONVENIENCE ONLY. PLANS TAKE PRECEDENCE. FINISHED GRADE BELOW ALL PLANTERS SHALL BE 1" BELOW
- ADJACENT HEADER, PAVING, CURBING, ETC. GROUNDCOVER AND/OR DG SHALL EXTEND UNDER SHRUBS
- UNLESS NOTED. 11. ALL EARTHWORK IS TO BE DONE SO THAT ALL WATER DRAINS AWAY FROM ALL STRUCTURES.
- ALL UNDERGROUND CONDUITS/PIPES/UTLITIES ARE TO BE LOCATED PRIOR TO DIGGING. 13. ALL MATERIAL TO BE GUARANTEED PER WARRANTY.
- CONTRACTOR IS RESPONSIBLE FOR ALL REQUIRED SLEEVING WHETHER IT IS SHOWN ON THE PLANS OR NOT.
- ADJUST NEW LANDSCAPE TO ACCOMMODATE EXISTING LANDSCAPE TO REMAIN.
- LANDSCAPE CONTRACTOR RESPONSIBLE TO MAINTAIN EXISTING PLANT MATERIAL TO REMAIN IN GOOD, HEALTHY CONDITION DURING CONSTRUCTION.
- 17. ALL STEEL HEADER TO BE 1/8" COLD ROLLED STEEL.



4th 602 602

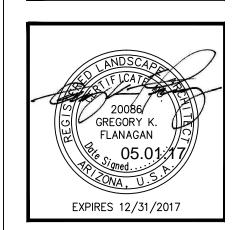

revisions: date: 05.01.17 contents: PLANTING sheet no. L-2

- A. DIMENSIONS ARE TO THE FACE OF EXISTING FINISH, NEW SUBSTRATE OR GRIDLINE. "CLEAR" DIMENSIONS ARE TO FACE OF FINISH.
- B. FIELD VERIFY ALL EXISTING CONDITIONS AND THEIR COMPATIBILITY WITH NEW CONSTRUCTION PRIOR TO THE COMMENCEMENT OF WORK. COORDINATE DISCREPANCIES WITH ARCHITECT.

THIRTY THREE NORTH

ARCHITECTS


2715 E Indian School. Road Phoenix, AZ 85016 p: 602.707.6240

C. DO NOT SCALE DRAWINGS.

MATERIAL LEGEND:




REYNOBOND PANEL - ZINC

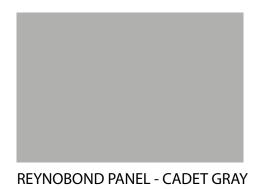




REYNOBOND PANEL - COPPER

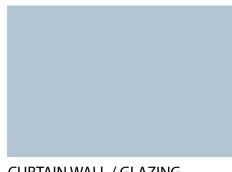

CURTAIN WALL / GLAZING

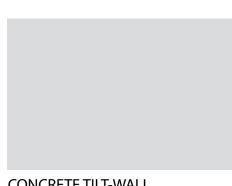

CONCRETE TILT-WALL



SCREEN/DETAIL - RUSTED METAL

ENLARGED ≥ BUILDING

PROJECT NO. 16007

DRAWN BY: MB CHECKED BY: LA

ELEVATIONS

©2017 33 NORTH ARCHITECTS, LLC

all dimensions and conditions at job site.

Drawings, written material, and design concepts shall not be used or reproduced in whole or part in any form or format without prior written consent of 33 North Architects. Do not scale drawings. Use given dimensions only. If not shown, verify correct dimensions with the Architect. Contractor shall check and verify

03.23.17

A3 NORTH ELEVATION

A3 EAST ELEVATION

1/8"=1'-0"

GENERAL NOTES:

- A. DIMENSIONS ARE TO THE FACE OF EXISTING FINISH, NEW SUBSTRATE OR GRIDLINE. "CLEAR" DIMENSIONS ARE TO FACE OF FINISH.
- B. FIELD VERIFY ALL EXISTING CONDITIONS AND THEIR COMPATIBILITY WITH NEW CONSTRUCTION PRIOR TO THE COMMENCEMENT OF WORK. COORDINATE DISCREPANCIES WITH ARCHITECT.

THIRTY THREE NORTH

ARCHITECTS

2715 E Indian School. Road Phoenix, AZ 85016 p: 602.707.6240


C. DO NOT SCALE DRAWINGS.









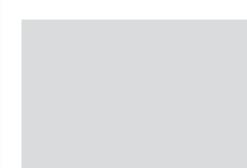



ENLARGED

©2017 33 NORTH ARCHITECTS, LLC


all dimensions and conditions at job site.


Drawings, written material, and design concepts shall not be used or reproduced in whole or part in any form or format without prior written consent of 33 North Architects. Do not scale drawings. Use given dimensions only. If not shown, verify correct dimensions with the Architect. Contractor shall check and verify

03.23.17






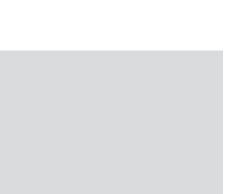

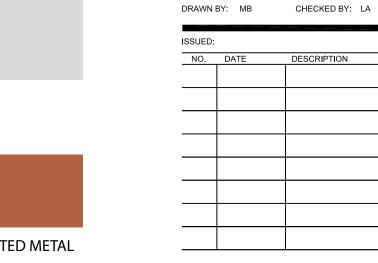

PROJECT NO. 16007

≥ BUILDING ELEVATIONS

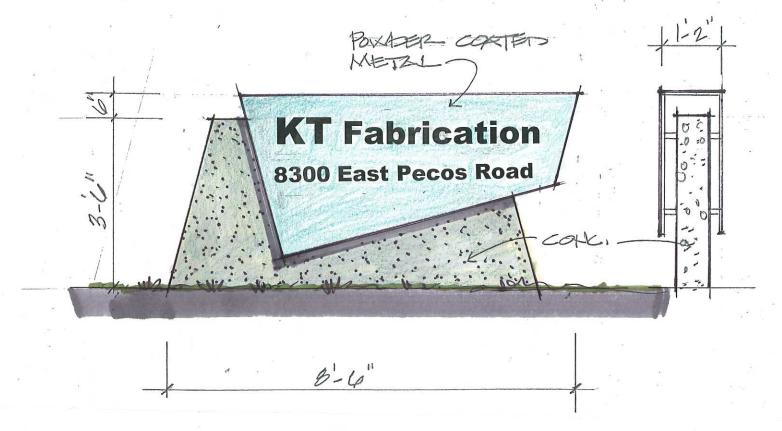

MONUMENT SIGN

- Two sided
- Raised Black letters
- Ground lighting
- Concrete Base
- Powder Coated Metal Sign

SPR, DR & LS APPLICATION NARRATIVE - REVISED

8300 E Pecos Road

Submitted on behalf of:



Submitted by:

Welker Development Resources

Jeff D Welker 3125 E Dover Street Mesa, AZ 85213

Phone: (480) 209-7167 Email: jeffw@wdrllc.net

Submitted to:

The City of Mesa 55 N Center Street Mesa, AZ 85201

May 1, 2017

A. PROJECT REQUESTS

Welker Development Resources, LLC ("Applicant"), on behalf of East Comstock, LLC ("Owner"), respectfully requests a Site Plan Review, Design Review, and Land Split for the commercial development of approximately approximately 14.5 acres of undeveloped agricultural/farm land located on the south side of East Pecos Road - the 8300 block. Also known as a portion of Maricopa County Parcel #314-61-014C ("Property").

B. PROJECT DESCRIPTION

The Owner proposes to relocate and expand his existing business (KT Fabrication) from it's current location in Chandler to this site in Mesa. KT Fabrication currently employees 180 people and manufactures custom building wall systems, aluminum window systems, ornamental metals and ACM panels. Their current location does not provide room for expansion, thus the interest in relocating.

As represented on the conceptual site plan, the Owner proposes a two-phased development approach. Phase one will involve approximately 6.37 acres adjacent to Pecos Road. This includes a 7,150 s.f. 2-story office building attached/fronting a 38,400 s.f. warehouse. It also provides for a nearly 20,000 s.f. future building expansion that would serve architecturally as a continuation of the warehouse design and functionally for material storage. Phase two allows for further expansion on the remaining 8.18 acres. All proposed parking, landscaping and building design elements will be consistent with Mesa's development standards.

C. Existing and Surrounding Site Uses

The surrounding zoning and uses are identified as follows:

	Existing Zoning	Current General Plan	Existing Use(s)
North 314-61-014B 304-61-002W	LI - Light Industrial	Employment	Pecos Road Agricultural/Farming METSO Minerals Industries
South 304-61-012S 304-61-012L	LI - Light Industrial	Employment	Agricultural/Farming & RV Storage Facility
East 304-61-014C	LI - Light Industrial	Employment	Agricultural/Farming
West 304-61-013A 304-61-014B	LI - Light Industrial	Employment	Agricultural/Farming & METSO Minerals Industries

D. Location and Accessibility

The site is located approximately ¾ of a mile east of the intersection of Pecos Road and Sossaman Road. Primary access will be from Pecos Road via two proposed commercial driveways.

E. Circulation System

The site is near the intersection of two major arterial street intersections and will not have a significant impact on the surrounding circulation system. The on-site circulation will be simply controlled by the proposed drive aisles as indicated on the conceptual site plan. Width of the onsite drive aisles are sized to accommodate large commercial vehicles, two way normal vehicular movements, and emergency vehicle access/maneuverability.

F. Community Facilities and Services

Due to the nature of the type of proposed use, additional services such as parks, schools, or other regional amenities are not needed or required.

G. Public Utilities and Services

It is anticipated that the existing City of Mesa 20-inch public water mainline and 18-inch public sewer mainline, both located in Pecos Road, will be of sufficient size and capacity to serve the potable, wastewater, and fire protection system needs for this proposed development.

H. Stormwater Drainage & Retention

Stormwater retention for this site will be maintained in proposed basins/areas as demonstrated on the conceptual site plan. The Owner's engineer will prepare the requisite drainage calculations and G&D design showing compliance with Mesa's adopted standards.

I. Architectural & Landscape Design

This proposed ground up new build project will house 7,150 s.f. of Administrative Office in a two story building facing Pecos Road and a 38,400 s.f. high bay Fabrication Shop which is positioned directly behind the office portion. The Fabrication building will be constructed of concrete tilt wall panels painted with a neutral light gray and patterned with a universal recessed jointing pattern. The building will have 20' W X 16' H rollup metal overhead doors place around the exterior. Above each door there will be a 20' wide steel faced LED lighting fixture that will be painted to match the used penny color of the horizontal metal stair screening. By incorporating the use of a single accent color on the office and fabrication areas the two distinctive parts pull together as single structure.

The portion of the project which faces Pecos Road will house the administrative operations. The building is designed as a signature of the group who will occupy the building showcasing their exceptional work in curtainwall window construction. The east side of the building will be full height curtainwall construction providing extensive light into the lobby which is angled to the northeast to take full advantage of the views of the Superstition Mountains. Visitors will enter from the east into the two story lobby. The west side two story section will house back of house and design and engineering functions. It will be clad in a medium gray colored horizontal metal providing a linear approach which then transfers around the west side to incorporate the horizontal metal screening that encloses an exterior exit stair. The screening will have the same used penny color as the horizontal light fixtures above the roll-up doors thus helping to tie the two parts of the building together. The medium gray color of the west end of the building provides a solid backdrop for the transparency of the curtainwall.

As demonstrated on the attached plans, the landscape concept proposed will incorporate low water use plant material focused on introducing color and form to the proposed landscape areas. The plant pallet consists of native and non-native plants found within the Arizona Department of Water Resources plant list and consistent with Mesa standards. The intent of the design is to create vibrancy and complement the architectural elements. Numerous landscape medians in the parking lot are proposed and the landscape area adjacent to the Pecos Road across the project's frontage is a major emphasis of the proposal.

J. Conclusion

The Owner intends to fully comply with all aspects of the LI zoning district, the Employment/Mesa Gateway sections of the Mesa 2040 General Plan, the Gateway Strategic Development Plan, and the Phoenix-Mesa Gateway Airport Airfield Overlay District. Accordingly, we respectfully request staff's support for this project as it progresses through Mesa required development processes.